


# CONNECTICUT DEPARTMENT OF TRANSPORTATION

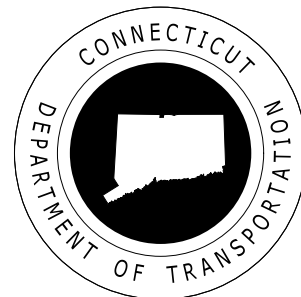


Plans For

## BRIDGE REPLACEMENT BRIDGE NO. 04682 DUBLIN HILL RD OVER PONSET BROOK

Town of  
HADDAM

ROAD	MAINTENANCE RESPONSIBILITY	LENGTH
DUBLIN HILL RD	STATE OF CONNECTICUT	324FT

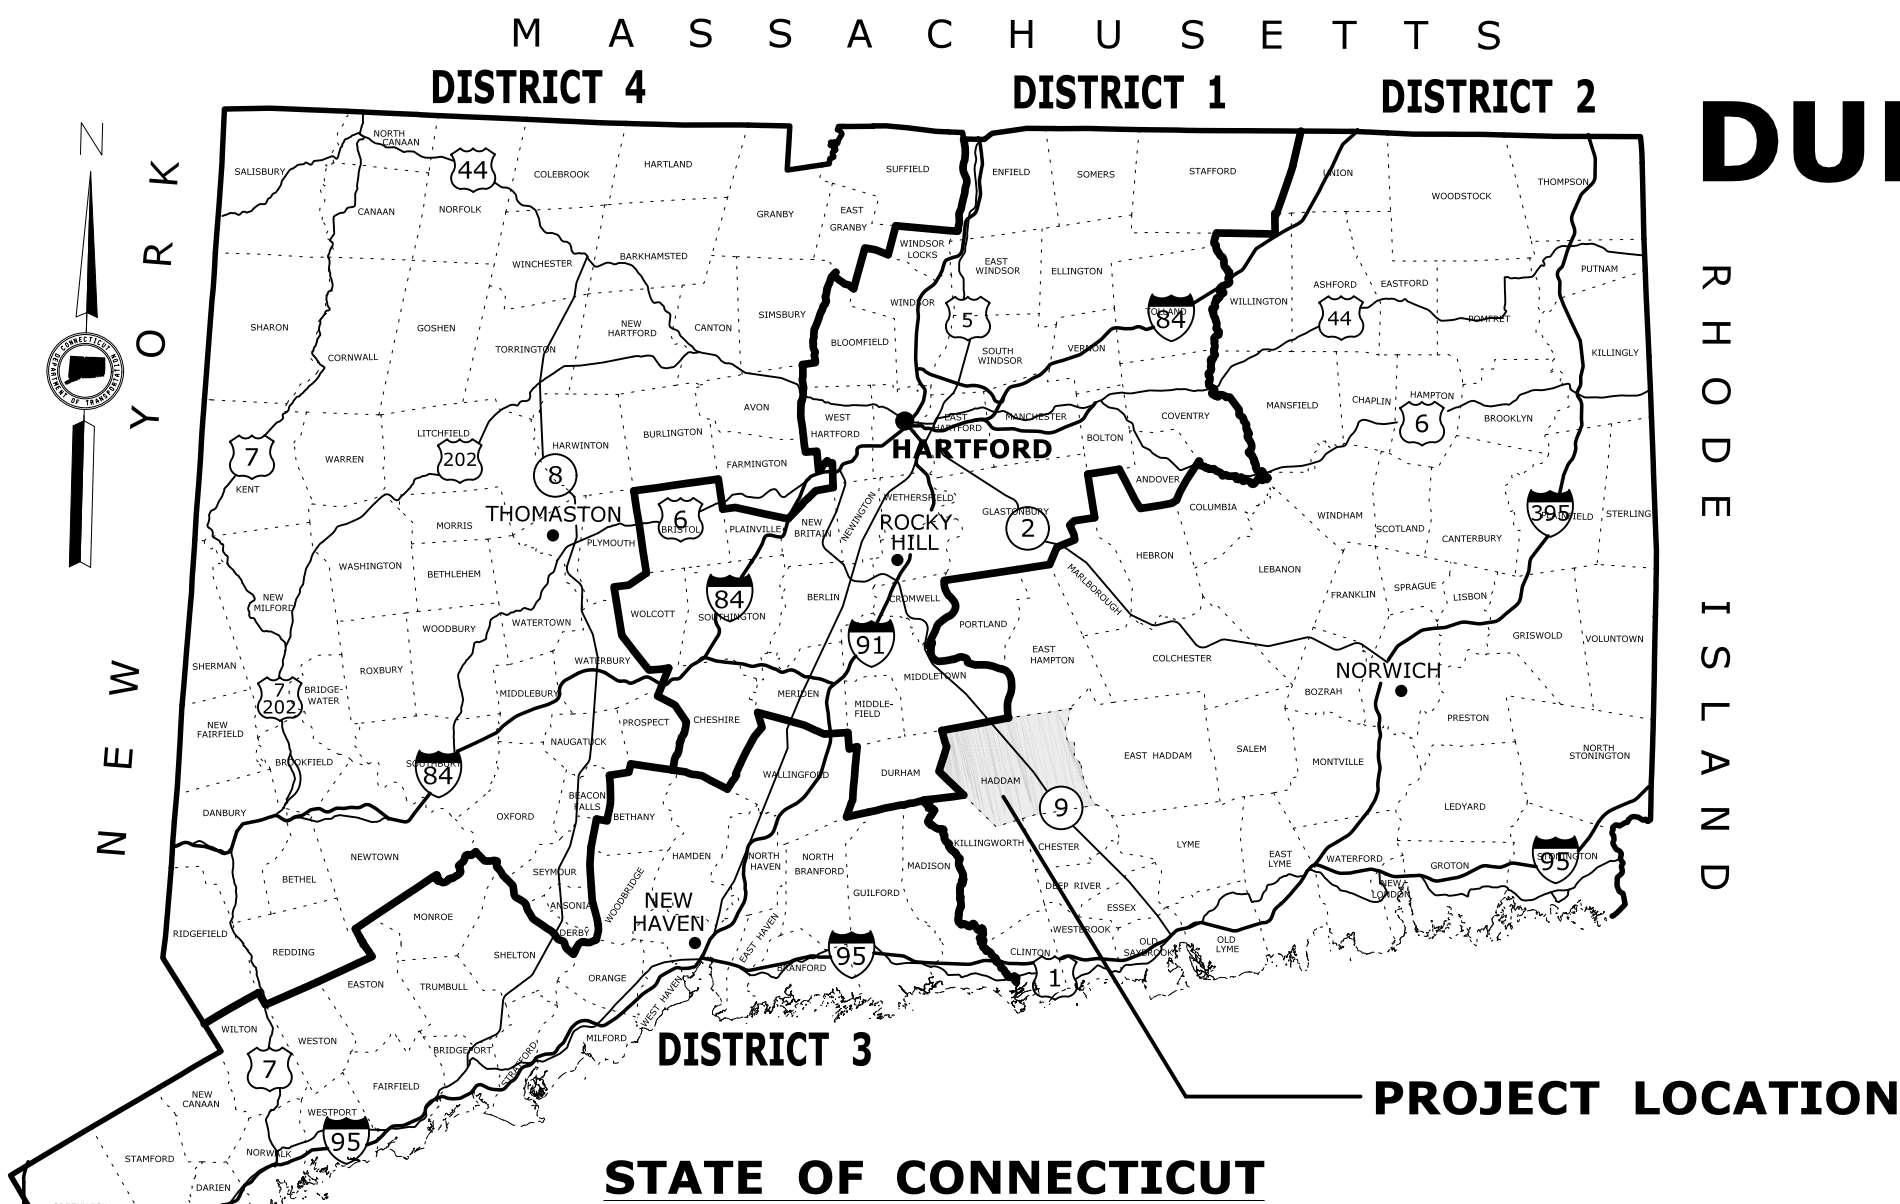



**GENERAL NOTES:**

- FEDERAL AID PROJECT NO. XXXXXX
- F.H.W.A. REGION NO. XXXX
- CONSTRUCTION SPECIFICATIONS:  
Connecticut Department of Transportation, Standard Specifications for Roads, Bridges, Facilities and Incidental Construction, Form 817, dated 2016; and Supplemental Specifications, dated July 2017; and Special Provisions
- 400 FOOT GRID BASED ON CONNECTICUT COORDINATE SYSTEM N.A.D. 83 (2011)
- VERTICAL DATUM BASED ON NAVD 1988

**DISCLAIMER**

IT IS THE RESPONSIBILITY OF EACH BIDDER AND ALL OTHER INTERESTED PARTIES TO OBTAIN ALL BIDDING RELATED INFORMATION AND DOCUMENTS FROM OFFICIAL SOURCES WITHIN THE DEPARTMENT.

PERSONS AND/OR ENTITIES WHICH REPRODUCE AND/OR MAKE SUCH INFORMATION AVAILABLE BY ANY MEANS ARE NOT AUTHORIZED BY THE DEPARTMENT TO DO SO AND MAY BE LIABLE FOR CLAIMS RESULTING FROM THE DISSEMINATION OF UNOFFICIAL, INCOMPLETE AND/OR INACCURATE INFORMATION.

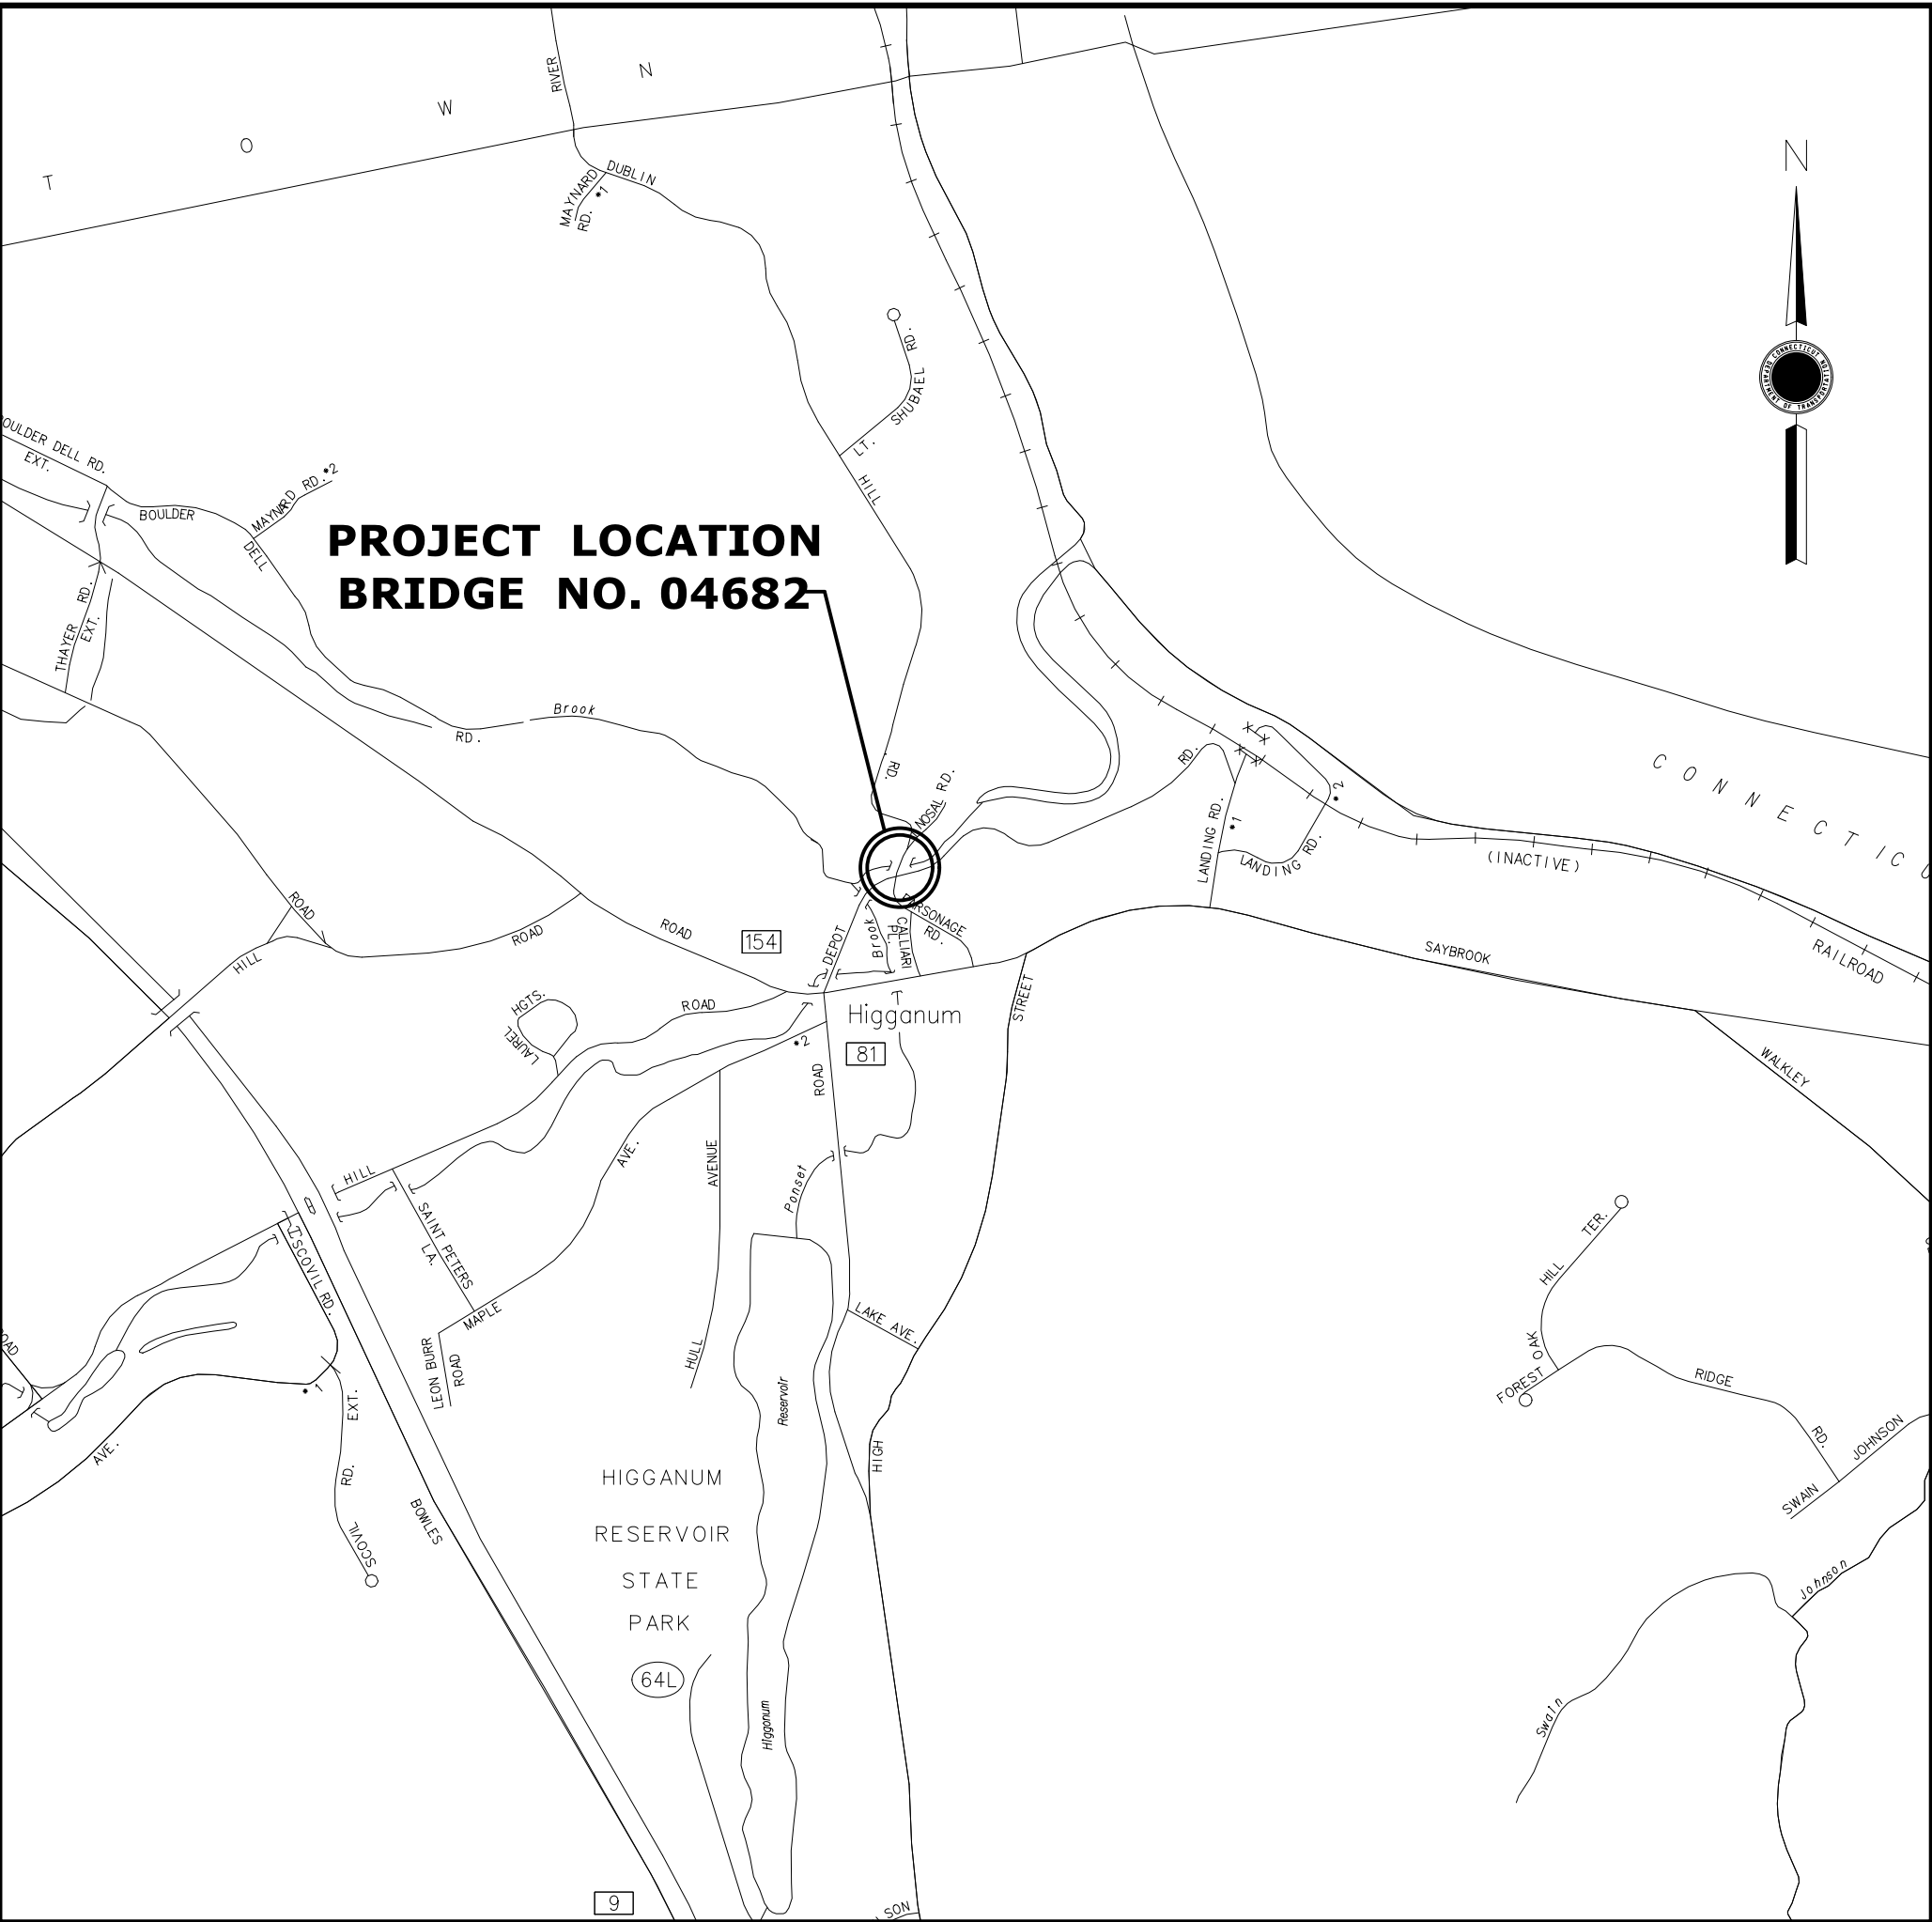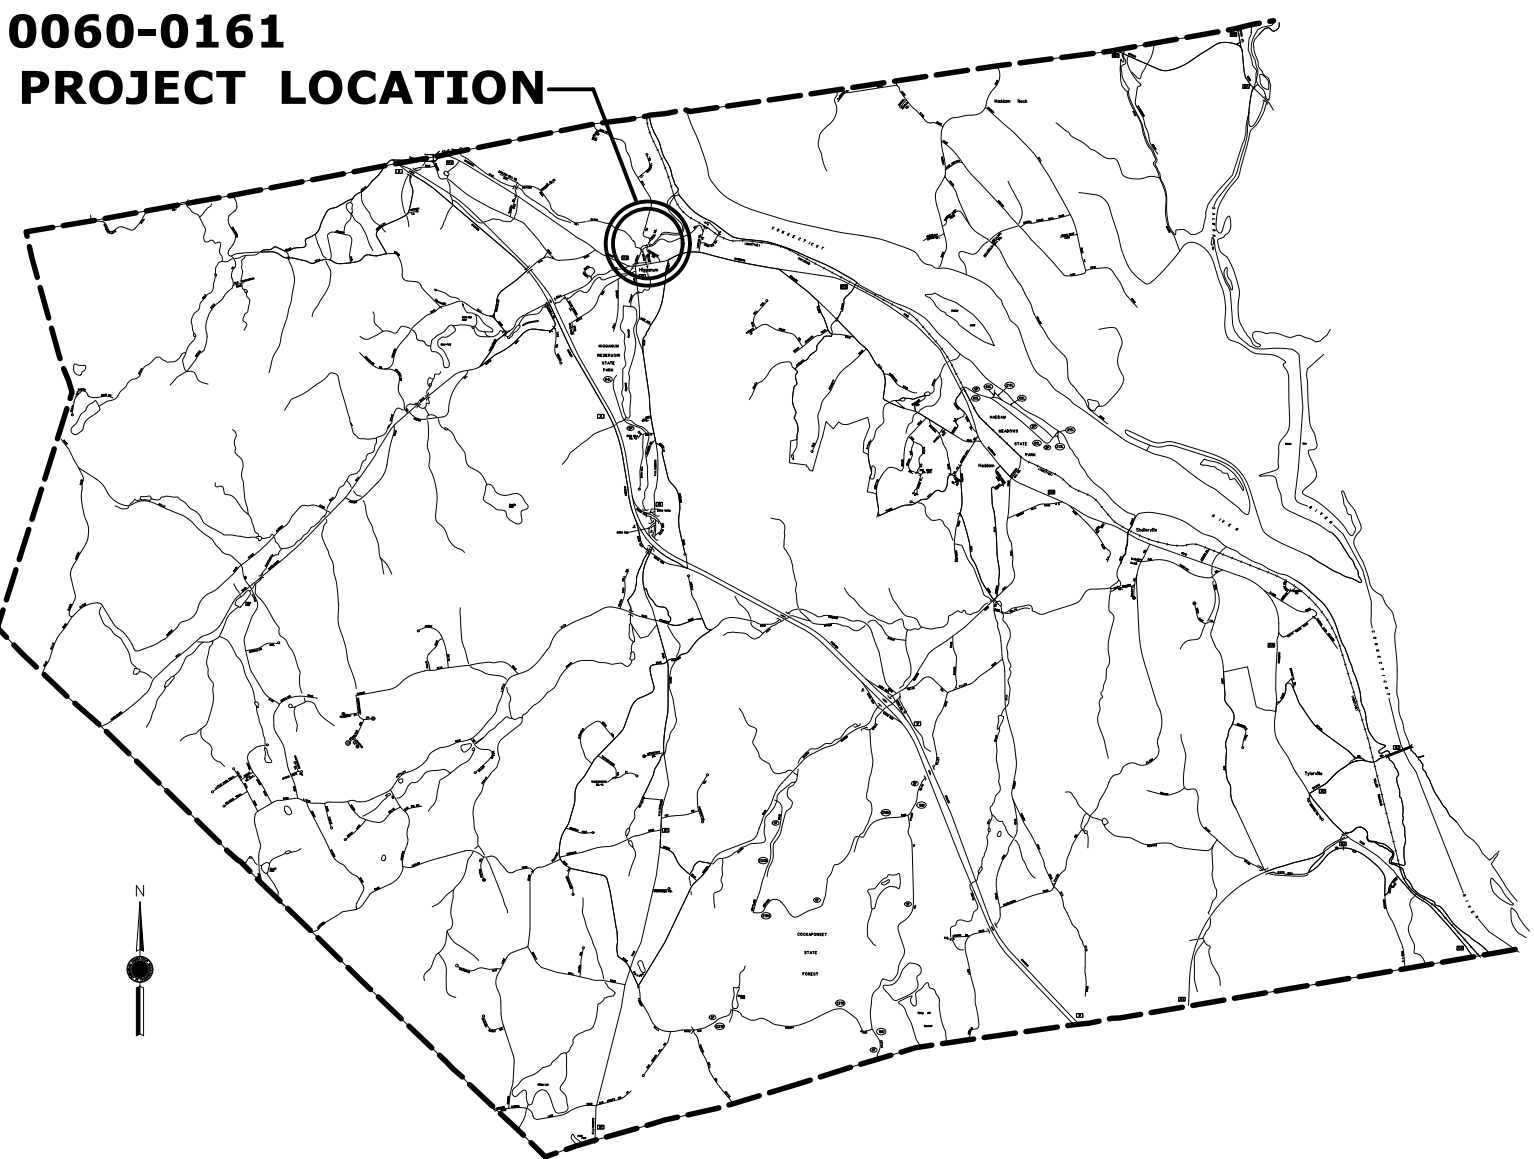

LOCATION PLAN  
SCALE  
NOT TO SCALE

TOWN OF HADDAM

LIST OF SUBSETS		
SUBSET NO.	SUBSET TITLE	*SUBSET SHEET COUNT
01	GENERAL	2
02	REVISIONS	1
03	HIGHWAYS	8
04	STRUCTURE	14
05	TRAFFIC	5
	HIGHWAY STANDARD SHEETS	-
	TRAFFIC STANDARD SHEETS	-

\*THE INITIAL SUBSET SHEET COUNT DOES NOT INCLUDE ADDENDUMS AND CHANGE ORDERS

LIST OF DRAWINGS SUBSET 01 - GENERAL	
DRAWING TITLE	DRAWING NO.
TITLE SHEET	G-01
DETAILED ESTIMATE SHEET	EST-01

STANDARD CONVENTIONS			
North Arrow W/No. Coord.	Grid Arrow	Chain Link Fence	Riprap
Edge Of Road	Limit Of Marsh	Rustic Fence	Hedge Row
Concrete Pavement	Stone Wall	Pipe Fence	Tree Line
Dirt Road	Ledge Outcrop	Board Fence	Shrub
B.C.L.C.	Inland Wetland Limits	Water Edge	Evergreen Tree
Granite Curb	STATE LINE	Stream	Deciduous Tree
Guide Rail	Power Line	Ditch	Retaining Wall
Concrete Median Barrier	Swamp	TOWN LINE	Highway Line
Bit. Walk	Building		Street Line
Conc. Sidewalk	Transmission Tower		Property Line
Railroad Tracks			Lot Line
			Easement Line

DESIGNED BY:  
A.DICESARE ASSOCIATES, P.C.  
690 CLINTON AVENUE  
BRIDGEPORT, CT 06604

70% DESIGN SUBMISSION

Plans For  
BRIDGE REPLACEMENT  
BRIDGE NO. 04682  
DUBLIN HILL ROAD OVER PONSET BROOK

Town  
HADDAM

STATE PROJECT NO.  
**0060-0161**

DRAWING NO.  
**G-01**  
SHEET NO.




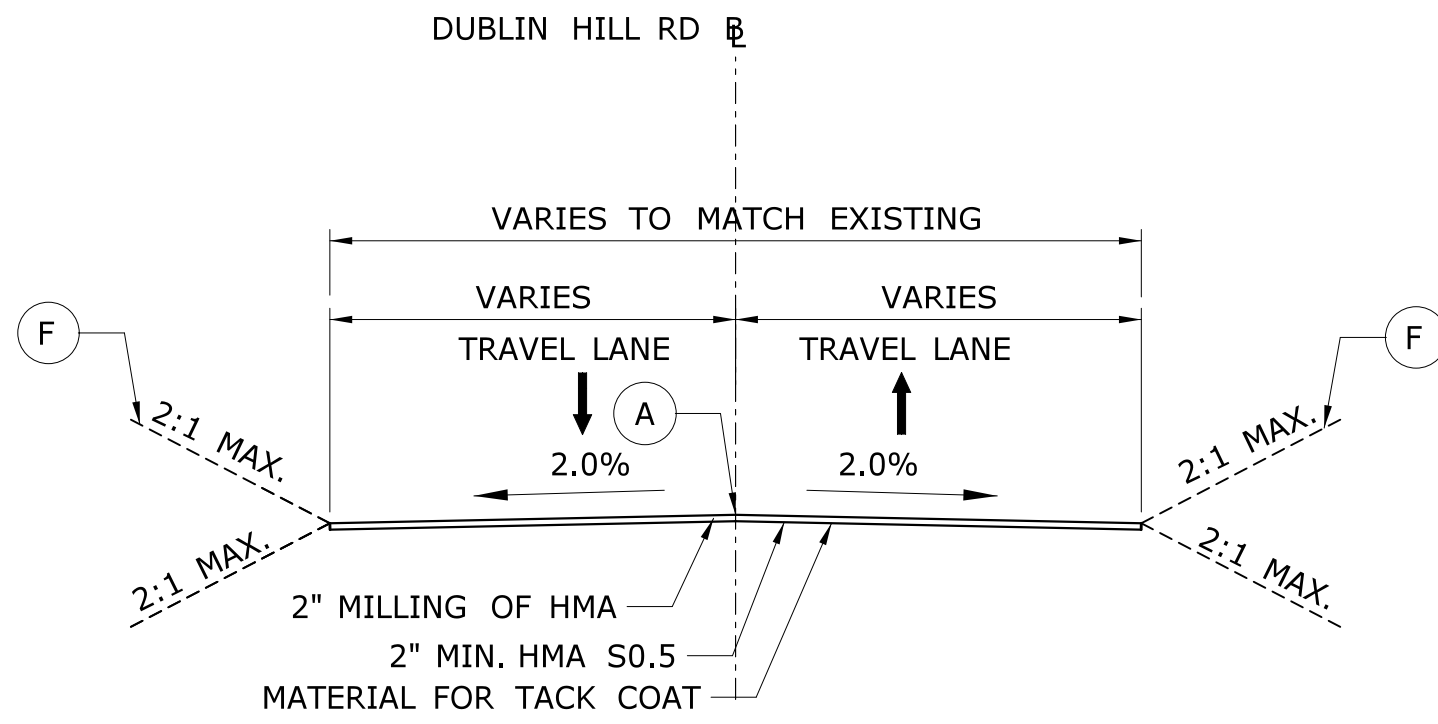
## 03 - HIGHWAY INDEX OF DRAWINGS

[illegible]

DESIGNED BY:  
A.DICESARE ASSOCIATES, P.C.  
BRIDGEPORT, CT


**70% DESIGN SUBMISSION**

-	-	-	-	THE INFORMATION, INCLUDING ESTIMATED QUANTITIES OF WORK, SHOWN ON THESE SHEETS IS BASED ON LIMITED INVESTIGATIONS BY THE STATE AND IS IN NO WAY WARRANTED TO INDICATE THE CONDITIONS OF ACTUAL QUANTITIES OF WORK WHICH WILL BE REQUIRED.	DESIGNER/DRAFTER: <b>AG</b>	 <b>STATE OF CONNECTICUT</b> <b>DEPARTMENT OF TRANSPORTATION</b>	SIGNATURE/ BLOCK:	PROJECT TITLE:  <b>BRIDGE REPLACEMENT</b> <b>BRIDGE NO. 04682 DUBLIN</b> <b>HILL ROAD OVER PONSET BROOK</b>	TOWN:  <b>EAST HADDAM</b>	PROJECT NO.  <b>060-161</b>
-	-	-	-	CHECKED BY: <b>ADC</b>	DRAWING NO.  <b>HWY-01</b>					
-	-	-	-							
-	-	-	-							
REV.	DATE	REVISION	DESCRIPTION	SHEET NO.	Plotted Date: 11/15/2017	Filename: ...\\HW_MSH_BR04682_060_161-HWY-01.dgn			DRAWING TITLE:  <b>INDEX OF HIGHWAY</b>	SHEET NO.




**APPROACH ROADWAY SECTION**

MILL AND OVERLAY  
STA. 0+25.88 TO STA. 0+66.83  
STA. 3+28.49 TO STA. 3+50

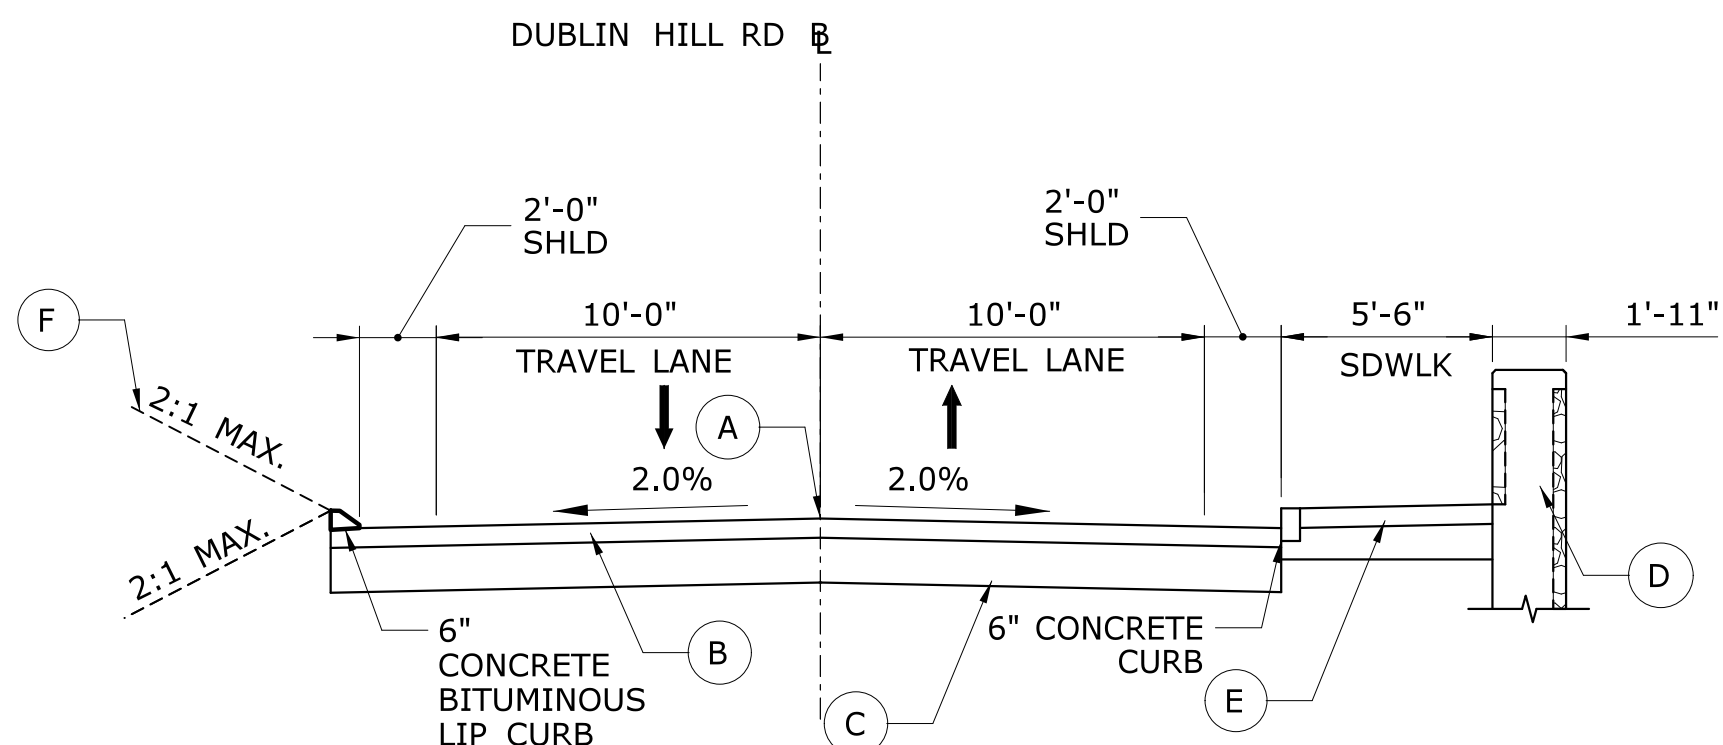


**ROADWAY SECTION**

FULL DEPTH PAVEMENT CONSTRUCTION  
STA. 2+08.72 TO STA. 2+38.31

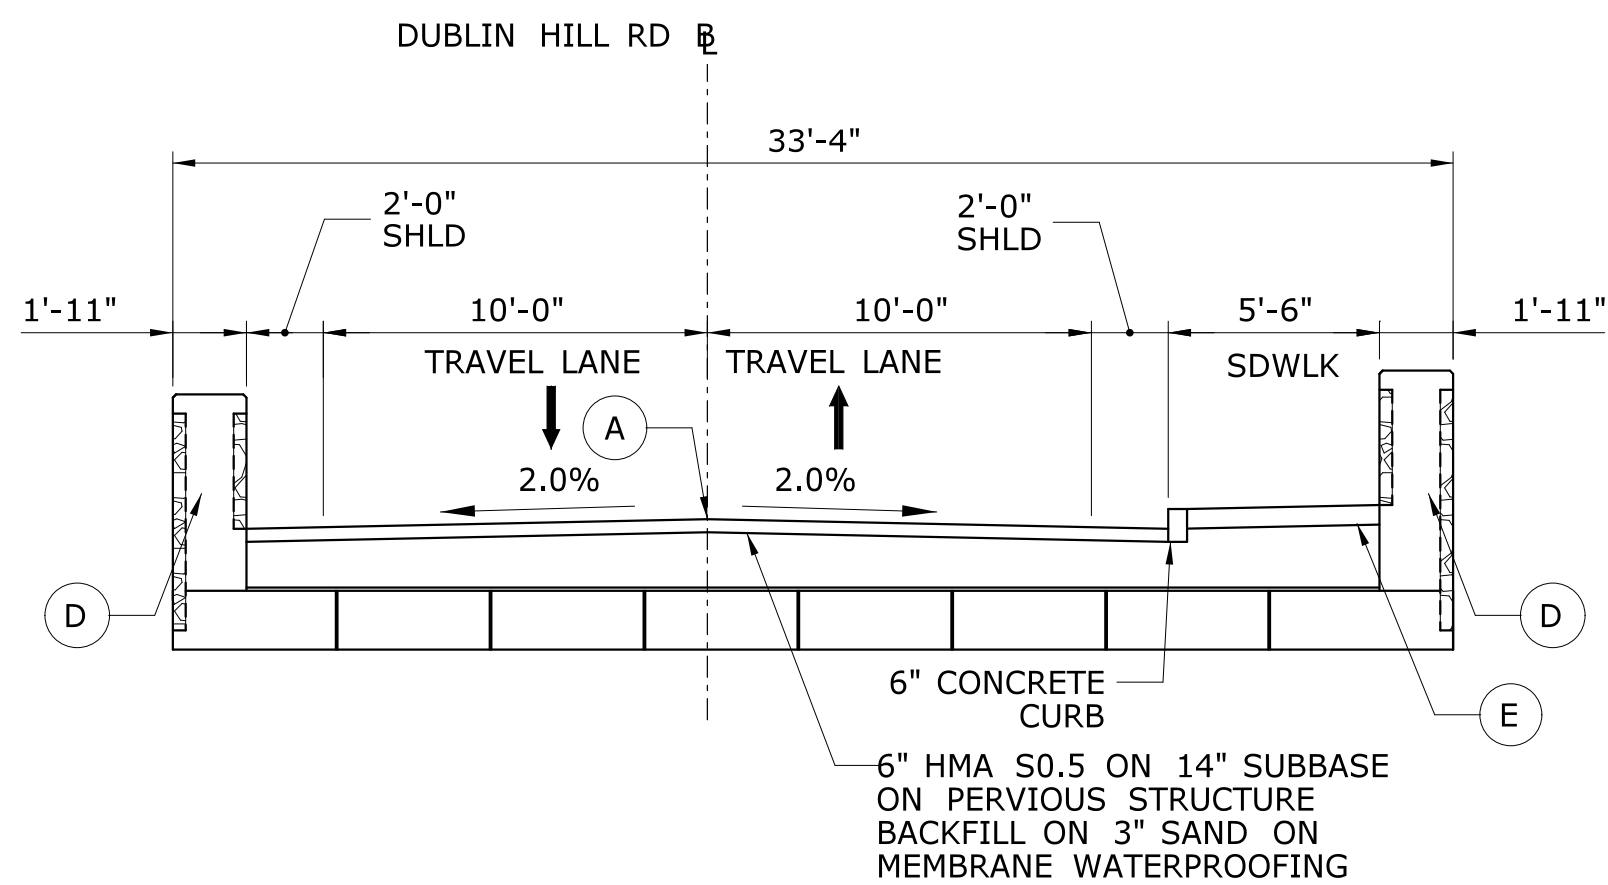


**BRIDGE ROADWAY SECTION**

STA. 1+01.31 TO STA. 1+94.31

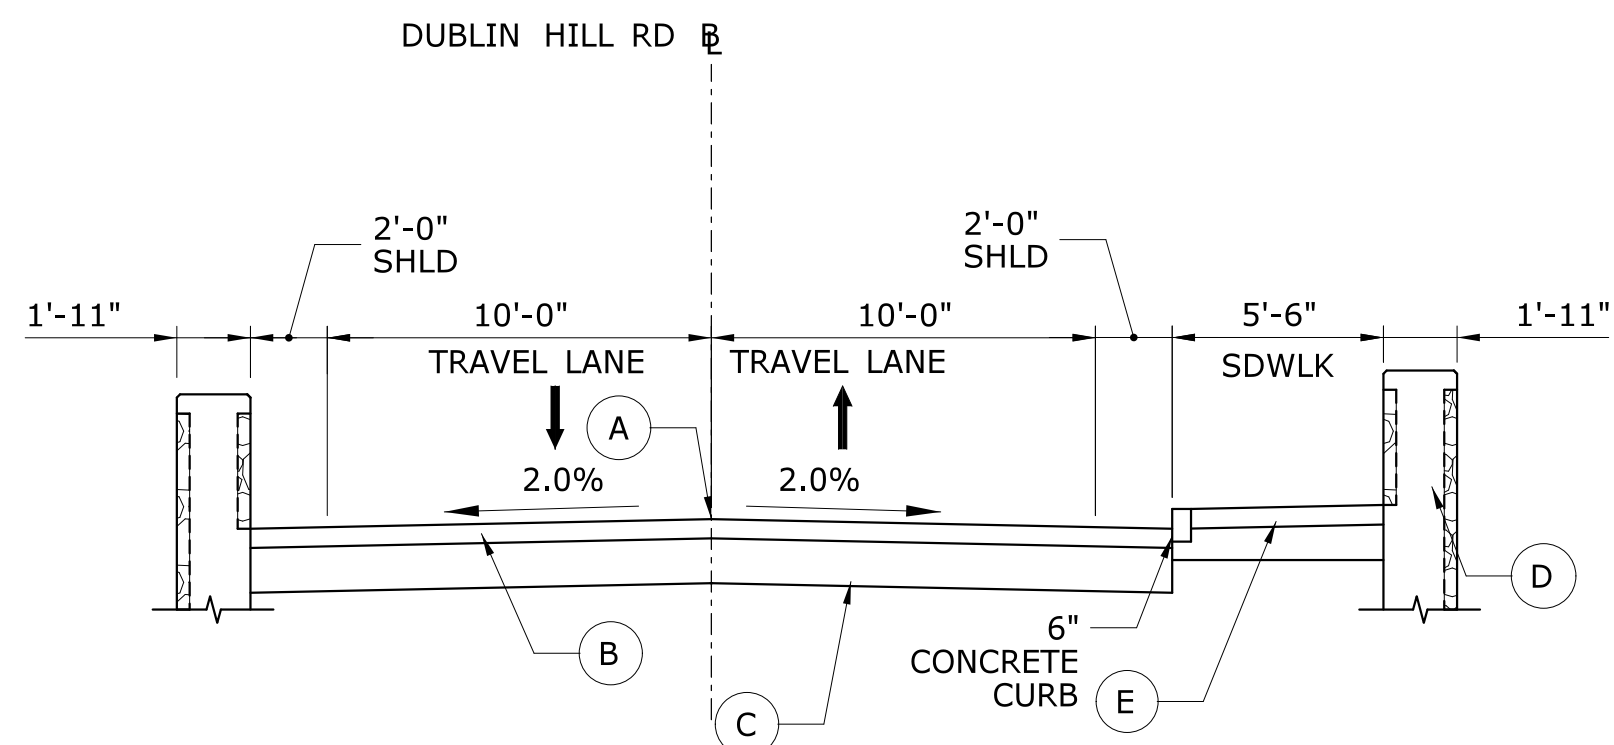

**ROADWAY SECTION**

FULL DEPTH PAVEMENT CONSTRUCTION  
STA. 0+89.81 TO STA. 1+01.31  
STA. 1+94.31 TO STA. 2+08.72

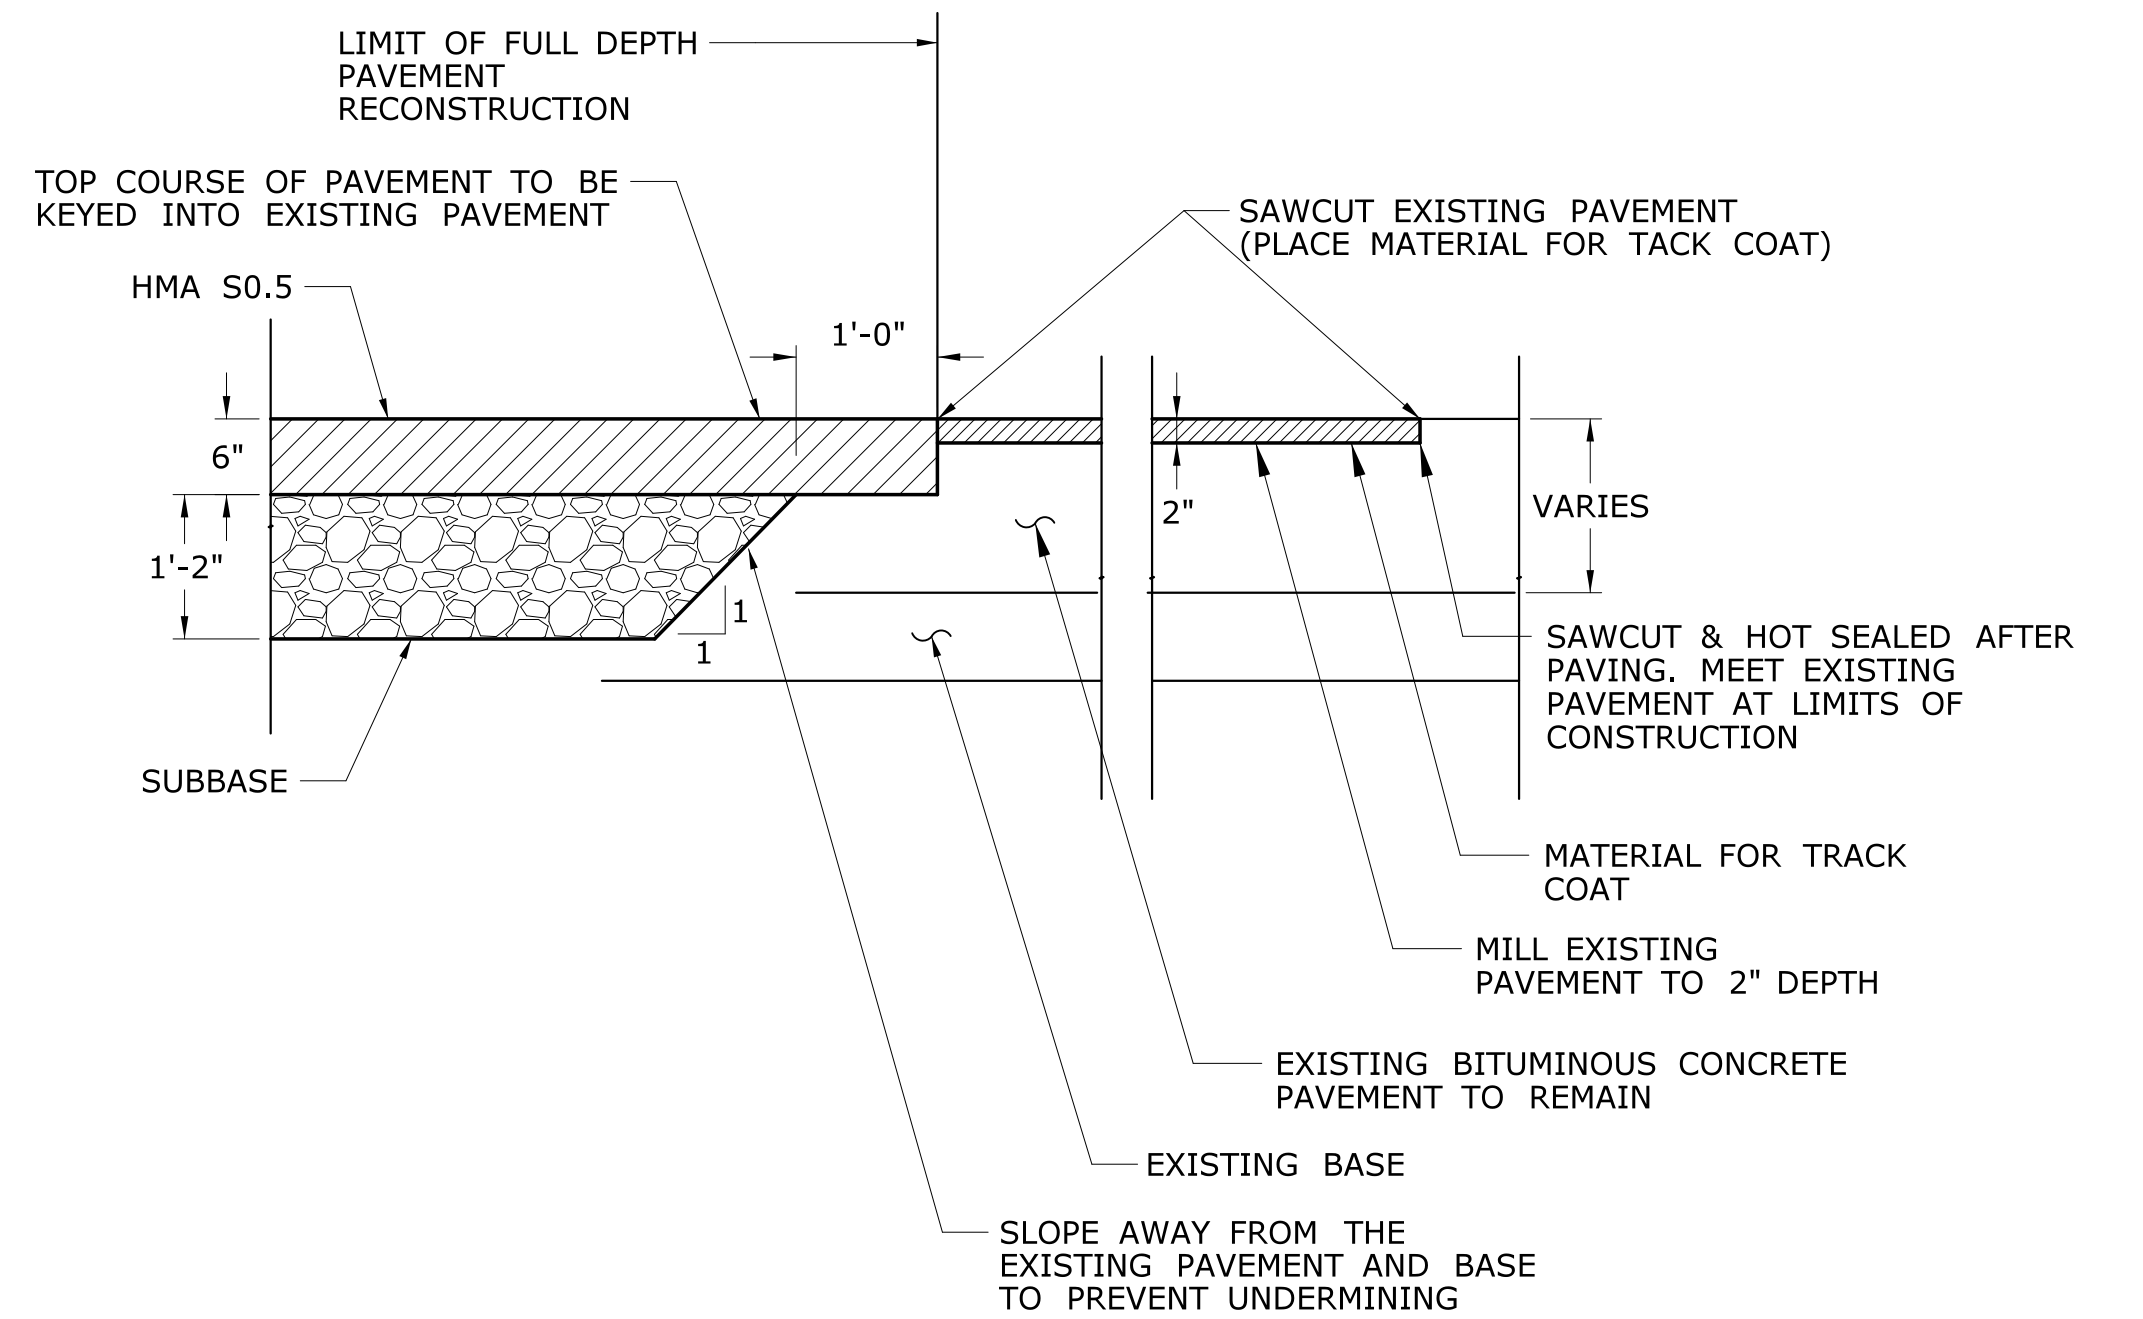


**ROADWAY PAVEMENT TRANSITION DETAIL**

SCALE: N.T.S.


**LEGEND**

- (A) POINT OF APPLIED GRADE
- (B) 6" HMA S0.5 (PLACED IN THREE EQUAL LIFTS)
- (C) 14" SUBBASE
- (D) SIMULATED STONE-FACED PARAPET OR WINGWALL, FOR LOCATIONS AND TYPE SEE PLANS
- (E) CONCRETE SIDEWALK AND GRANULAR FILL
- (F) 4" TOPSOIL AND TURF ESTABLISHMENT

**70% DESIGN SUBMISSION**

				DESIGNER/DRAFTER: <b>AG</b>		 <b>STATE OF CONNECTICUT</b> <b>DEPARTMENT OF TRANSPORTATION</b>	SIGNATURE/ BLOCK:	PROJECT TITLE:  <b>BRIDGE REPLACEMENT BRIDGE NO. 04682 DUBLIN HILL ROAD OVER PONSET BROOK</b>	TOWN:  <b>HADDAM</b>	PROJECT NO. <b>060-161</b>			
				CHECKED BY: <b>ADC</b>									
				<div>SCALE IN FEET</div> <div><div></div><div>0</div><div>5</div><div>10</div></div> <div>SCALE 1"= 5'</div>									
REV.	DATE	REVISION DESCRIPTION	SHEET NO.	Plotted Date: 11/15/2017		Filename: ...\\HW-MSH-BR04682-060-161-HWY-02.dgn		DRAWING TITLE: <b>TYPICAL ROADWAY SECTIONS</b>			DRAWING NO. <b>HWY-02</b>		
											SHEET NO.		



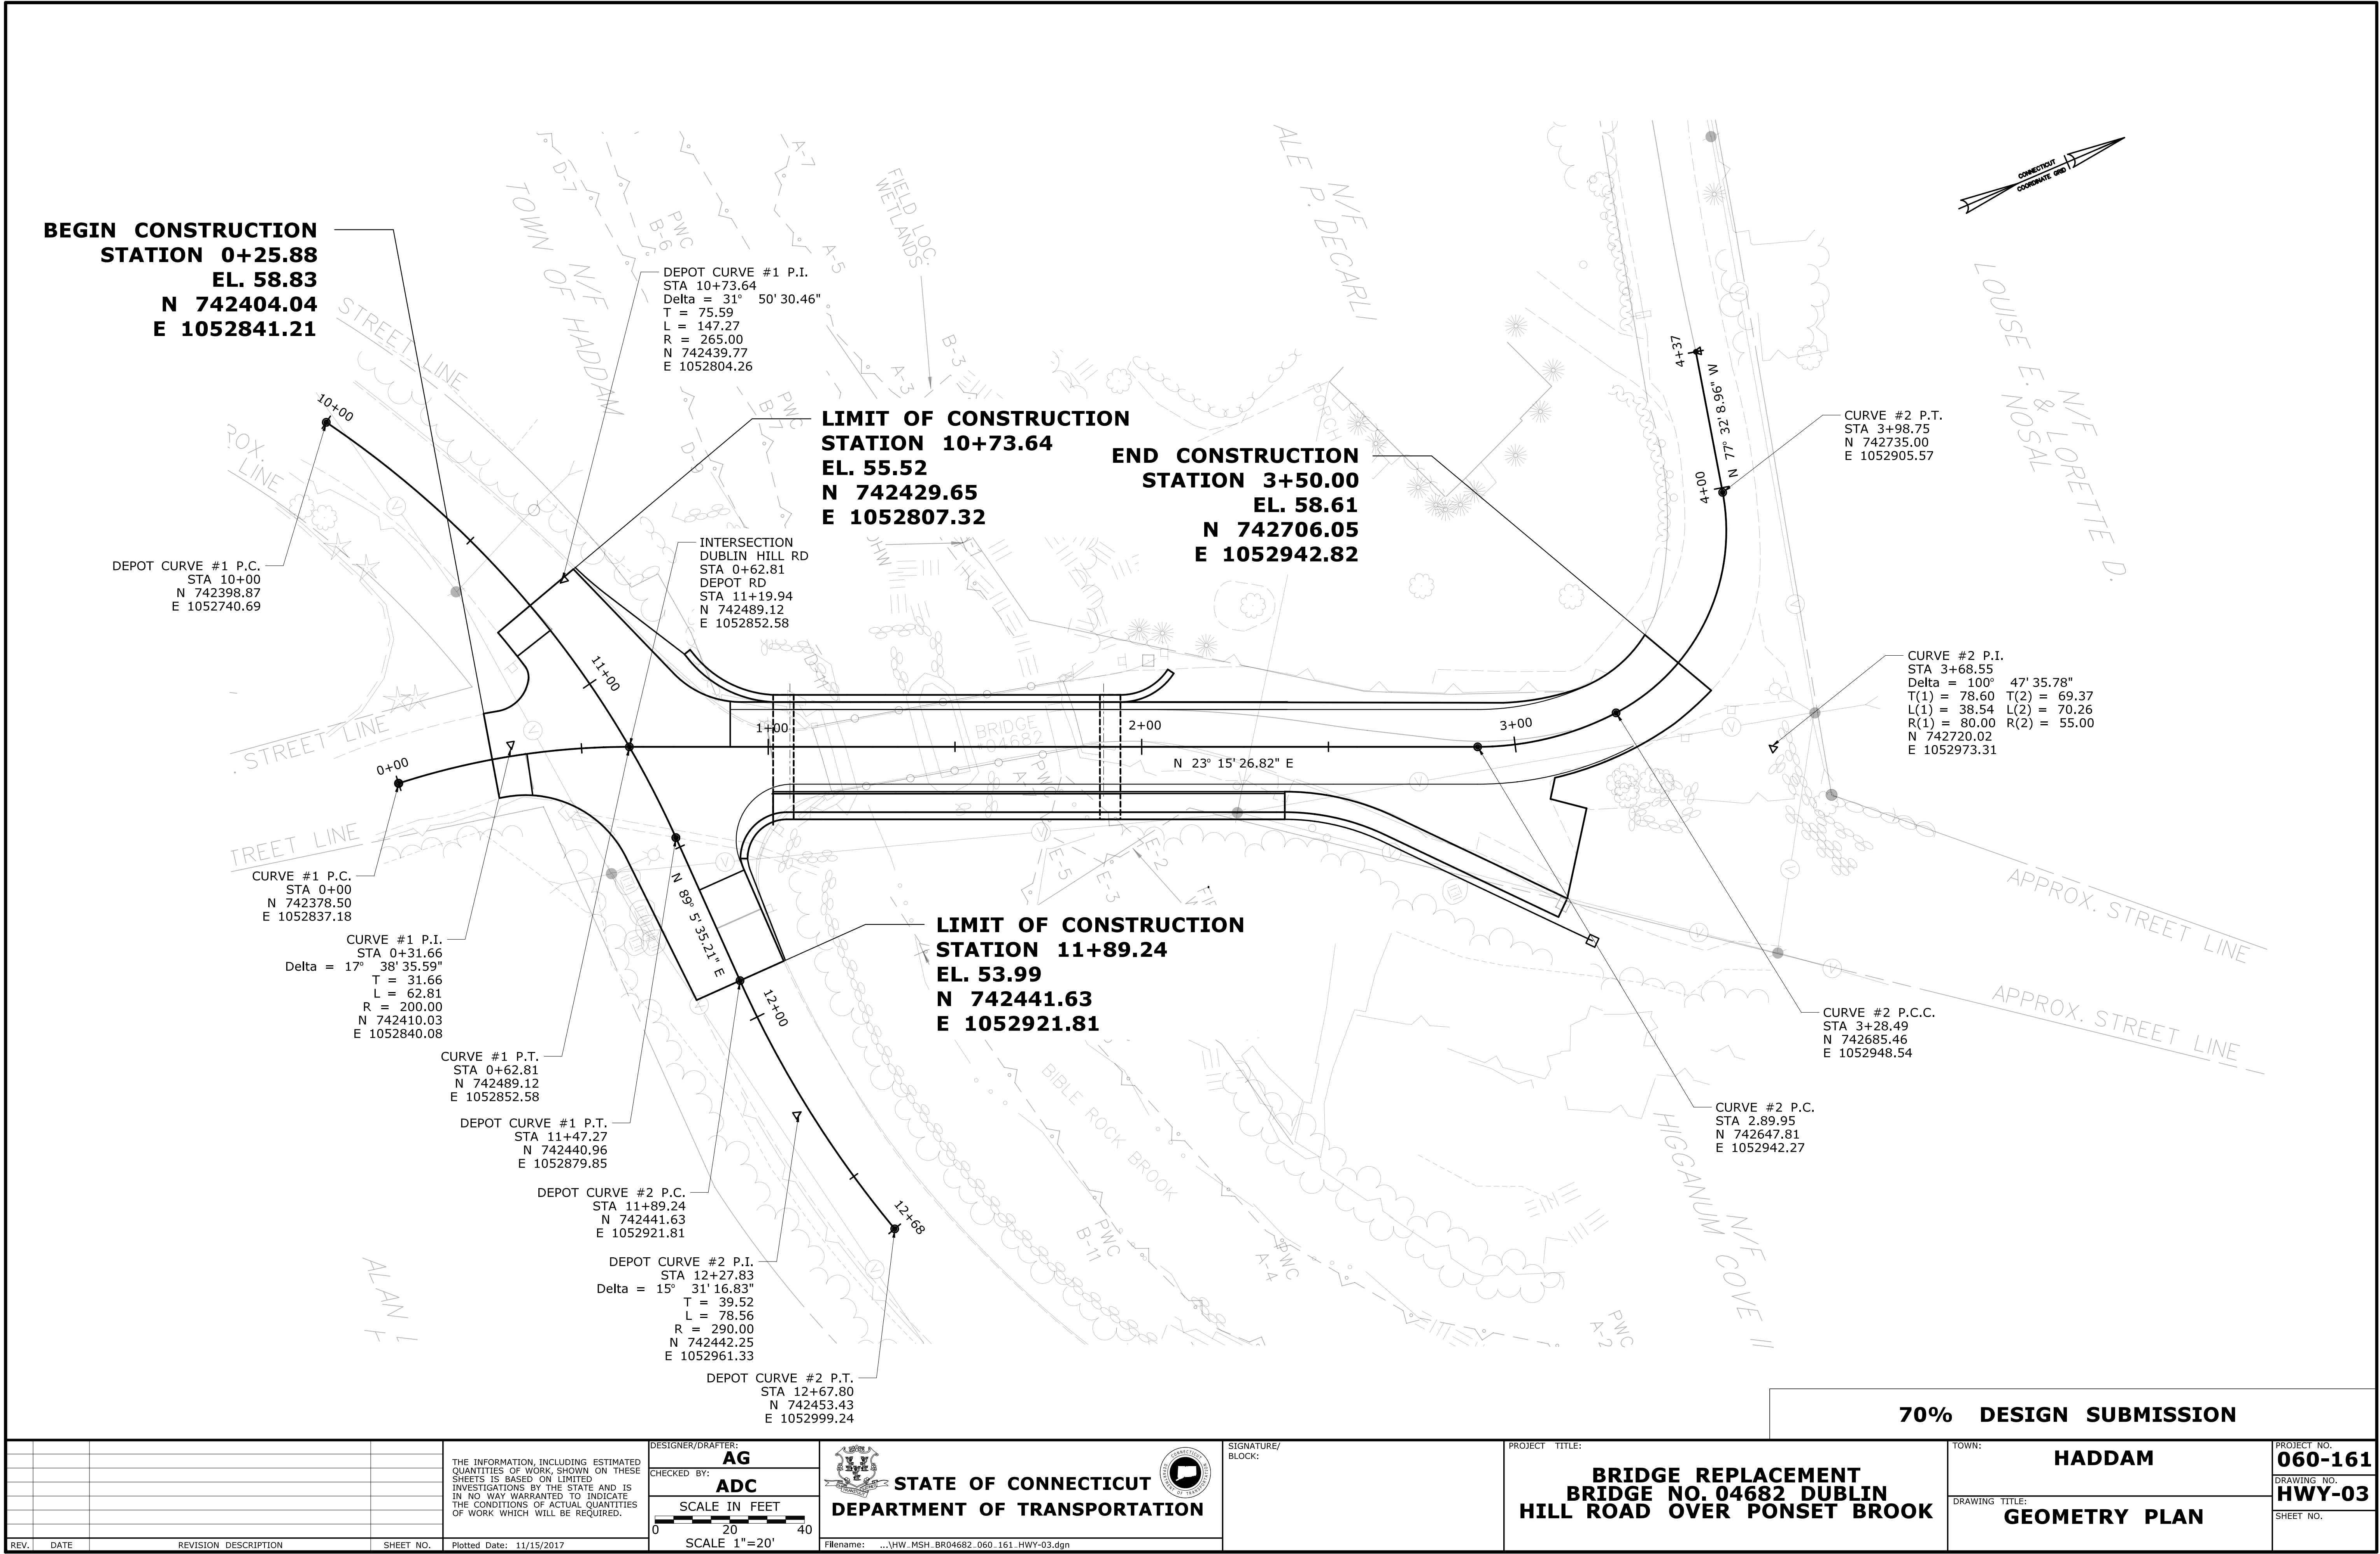

70% DESIGN SUBMISSION		PROJECT NO. 060-161	
TOWN: HADDAM		DRAWING NO. HWY-03	
DRAWING TITLE: GEOMETRY PLAN		SHEET NO.	

REV.	DATE	REVISION DESCRIPTION	SHEET NO.	Plotted Date: 11/15/2017

DESIGNER/DRAFTER: AG  
CHECKED BY: ADC  
SCALE IN FEET  
0 20 40  
SCALE 1"=20'

**STATE OF CONNECTICUT**  
**DEPARTMENT OF TRANSPORTATION**

Filename: ...\\HW..MSH..BR04682..060..161..HWY-03.dgn

SIGNATURE/  
BLOCK:


PROJECT TITLE:  
**BRIDGE REPLACEMENT  
BRIDGE NO. 04682 DUBLIN  
HILL ROAD OVER PONSET BROOK**

BEGIN PROJECT NO. 060-161

LIMITS OF MILL AND PAVE  
MATCH EXISTING PAVEMENT  
DUBLIN HILL RD @ STA 0+25.88  
EL. = 58.83

END PROJECT NO. 060-161

LIMITS OF MILL AND PAVE  
MATCH EXISTING PAVEMENT  
DUBLIN HILL RD @ STA 3+50.00  
EL. = 58.61

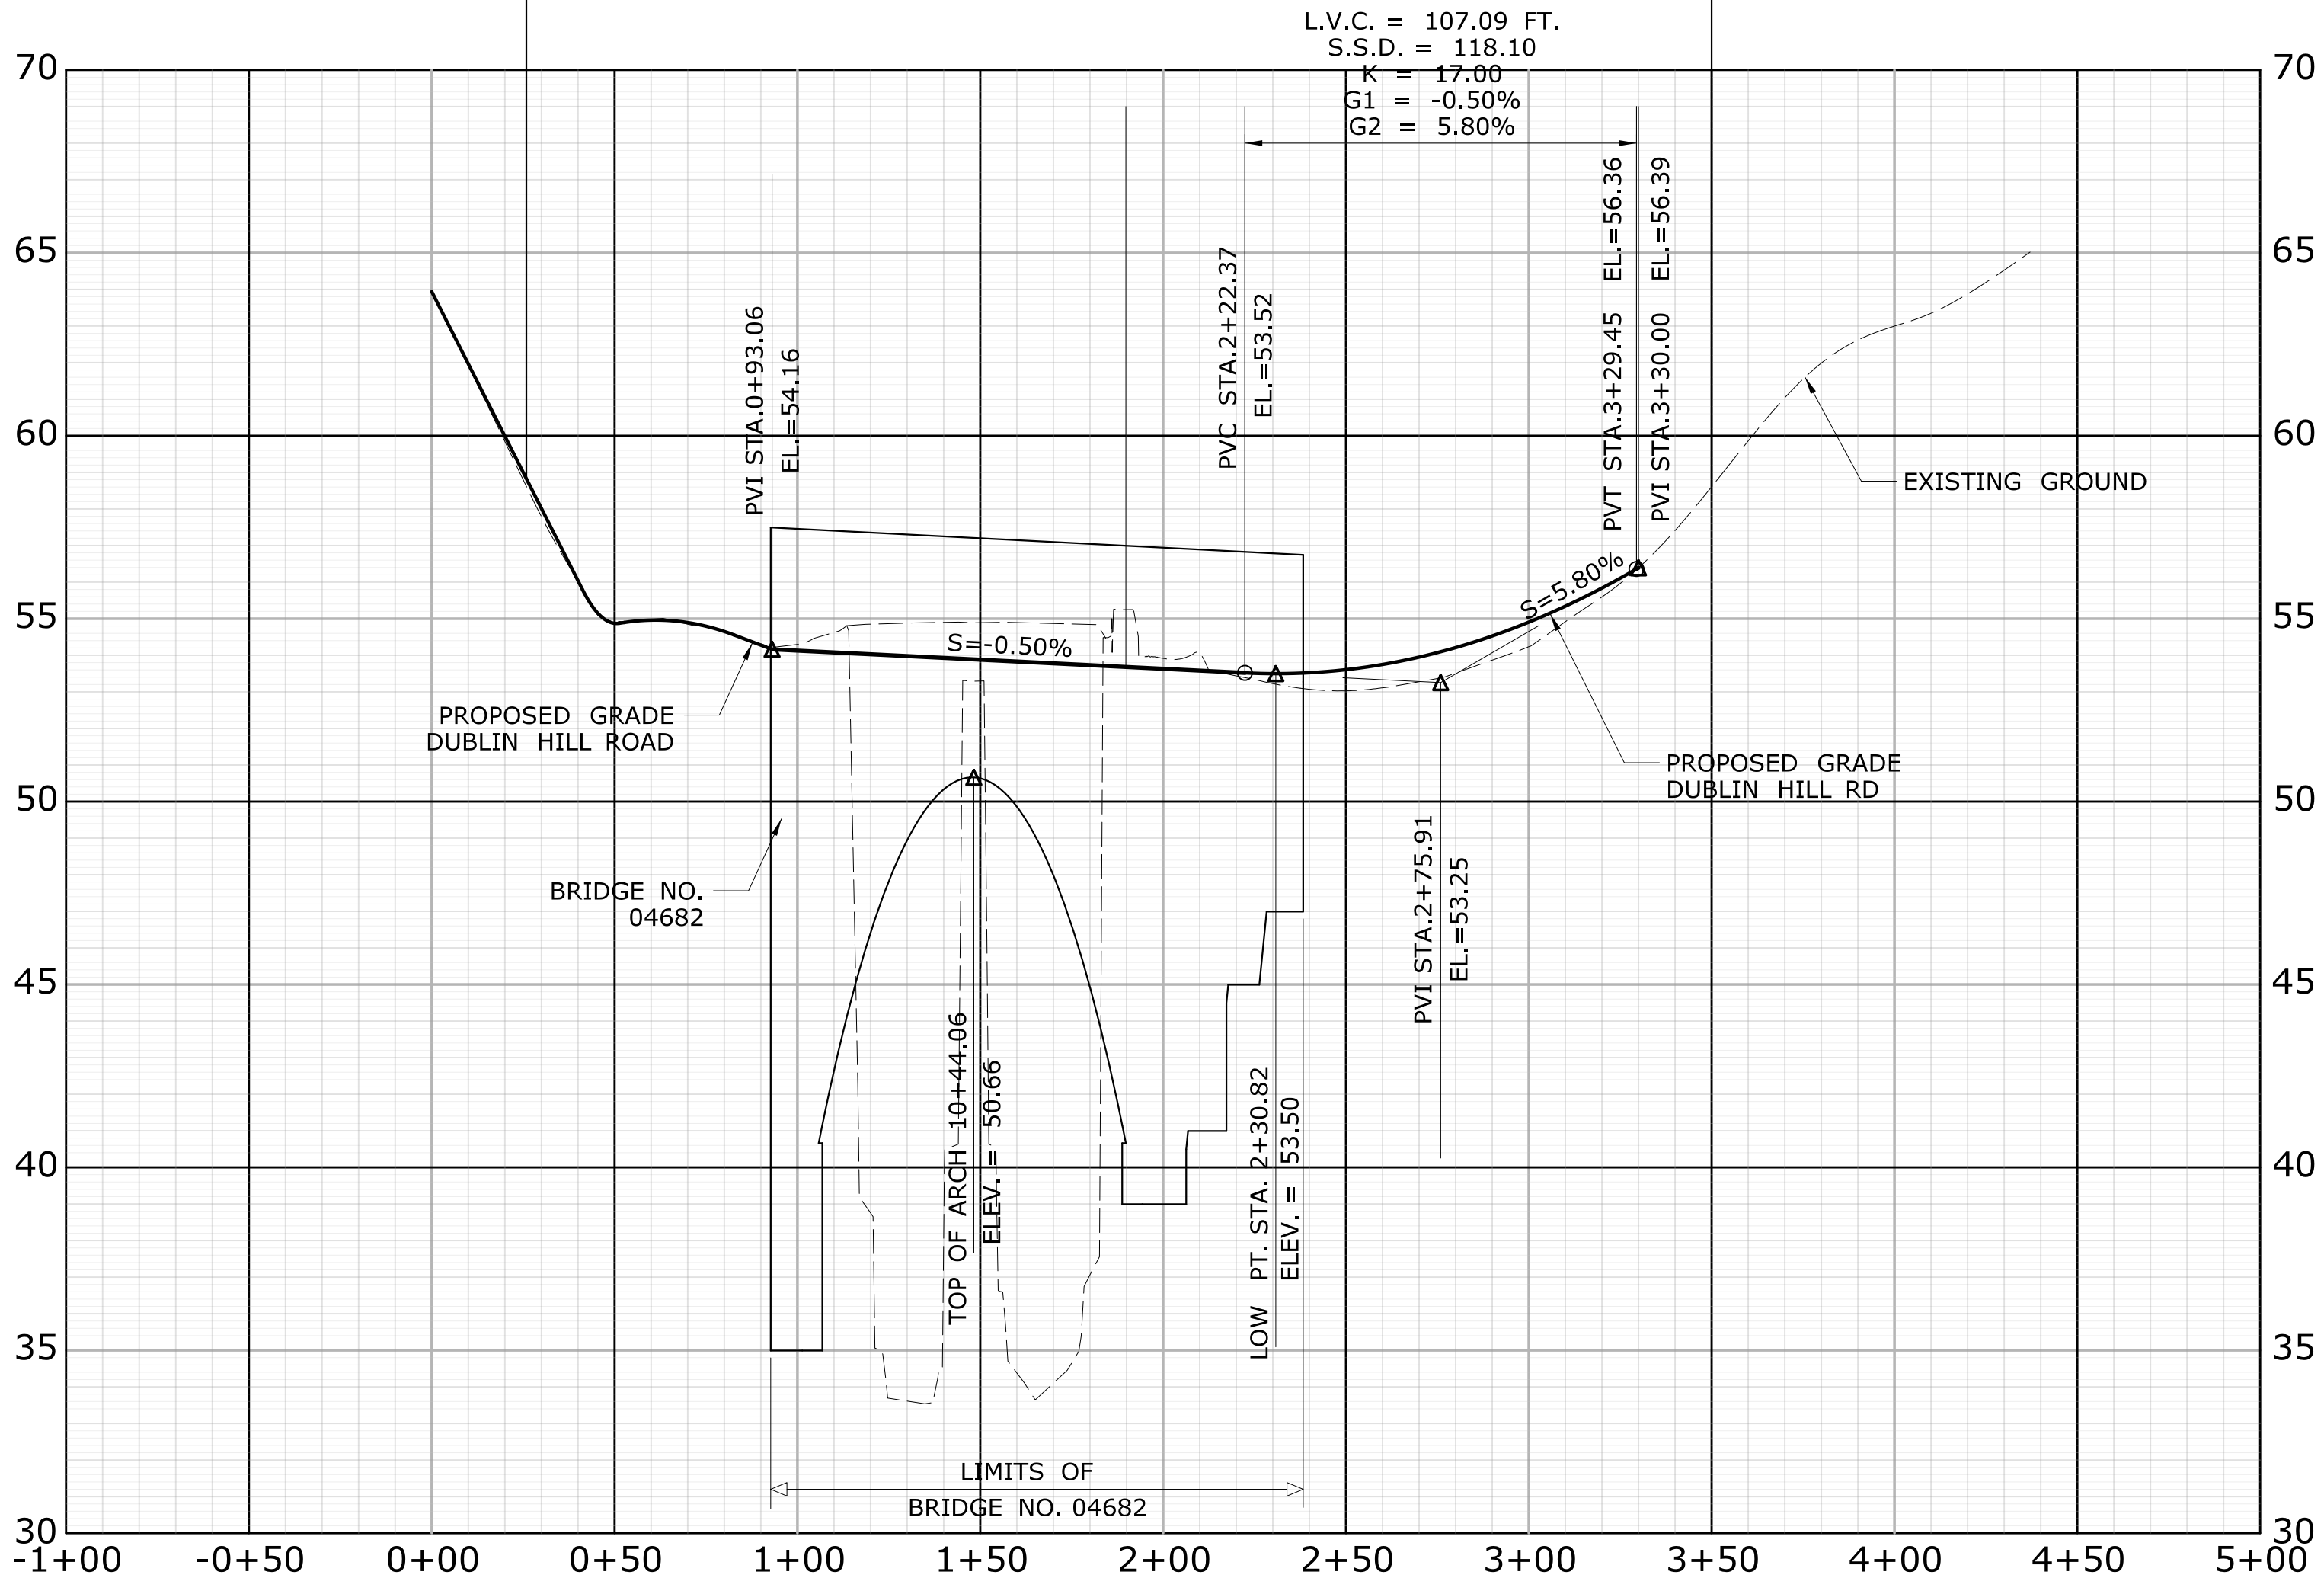

NOTES:


1. REFER TO ROADWAY PLANS, STAGE CONSTRUCTION PLANS AND CROSS SECTIONS FOR ADDITIONAL INFORMATION.
2. CONTRACTOR SHALL BE AWARE THAT ALL DRAINAGE STRUCTURES SHALL BE BUILT SUCH THAT THEY CAN ACCOMMODATE FINAL GRADE CONDITIONS.
3. CONTRACTOR TO MAINTAIN EXISTING DRAINAGE UNTIL NEW DRAINAGE IS OPERATIONAL.
4. REFER TO HWY-XXX FOR CATCH BASIN STRUCTURE INVERTS

70% DESIGN SUBMISSION

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THE INFORMATION, INCLUDING ESTIMATED QUANTITIES OF WORK, SHOWN ON THESE SHEETS IS BASED ON LIMITED INVESTIGATIONS BY THE STATE AND IS IN NO WAY WARRANTED TO INDICATE THE CONDITIONS OF ACTUAL QUANTITIES OF WORK WHICH WILL BE REQUIRED.



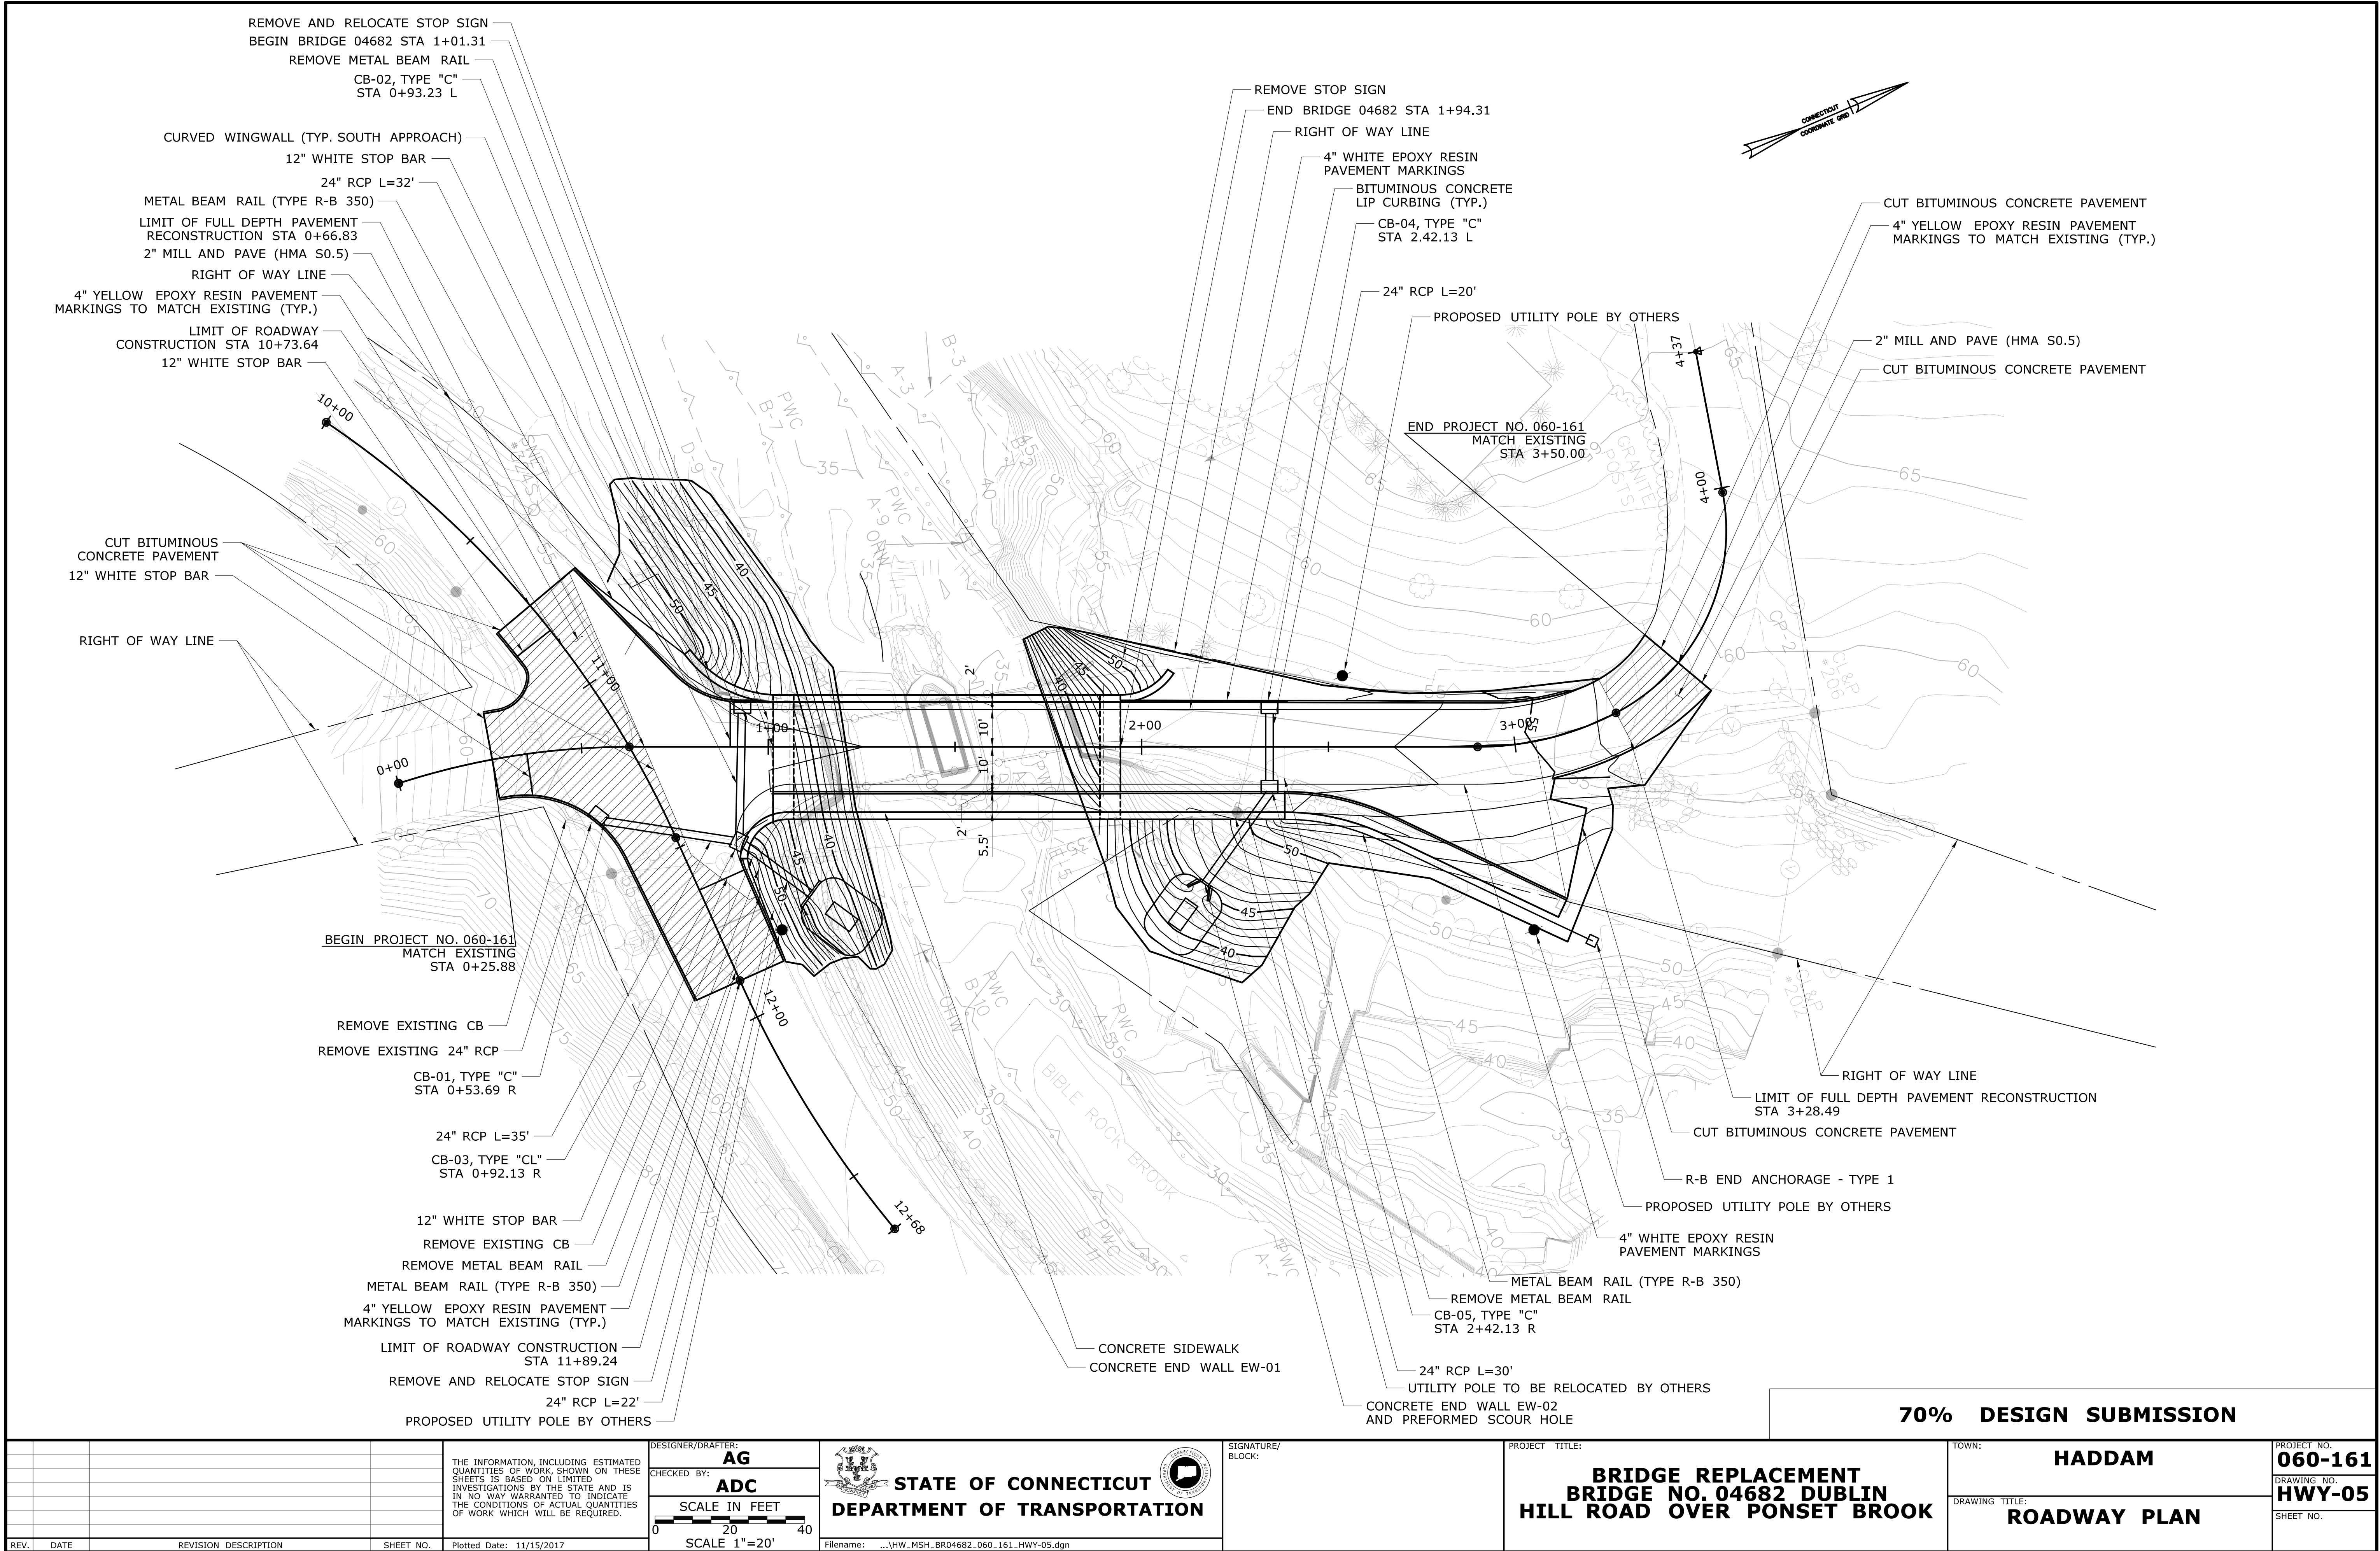

REV.	DATE	REVISION DESCRIPTION	SHEET NO.


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Plotted Date: 11/15/2017

DESIGNER/DRAFTER:  
**AG**

CHECKED BY:  
**ADC**

SCALE IN FEET  
0 20 40  
SCALE 1"=20'

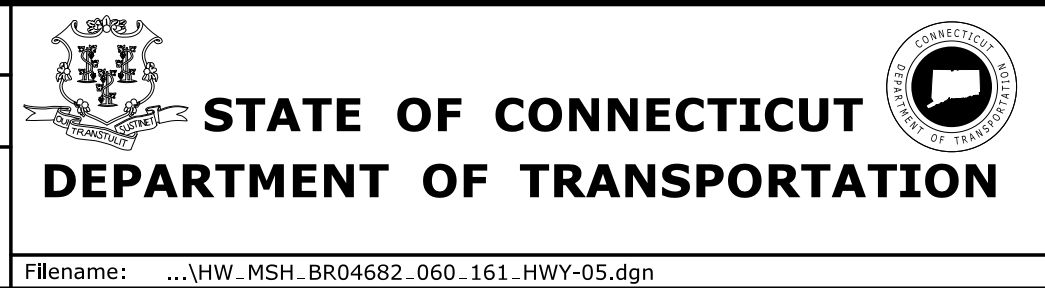

SIGNATURE/  
BLOCK:

PROJECT TITLE:  
**BRIDGE REPLACEMENT  
BRIDGE NO. 04682 DUBLIN  
HILL ROAD OVER PONSET BROOK**


TOWN:  
**HADDAM**

DRAWING TITLE:  
**ROADWAY PLAN**

PROJECT NO.  
**060-161**



DRAWING NO.  
**HWY-05**

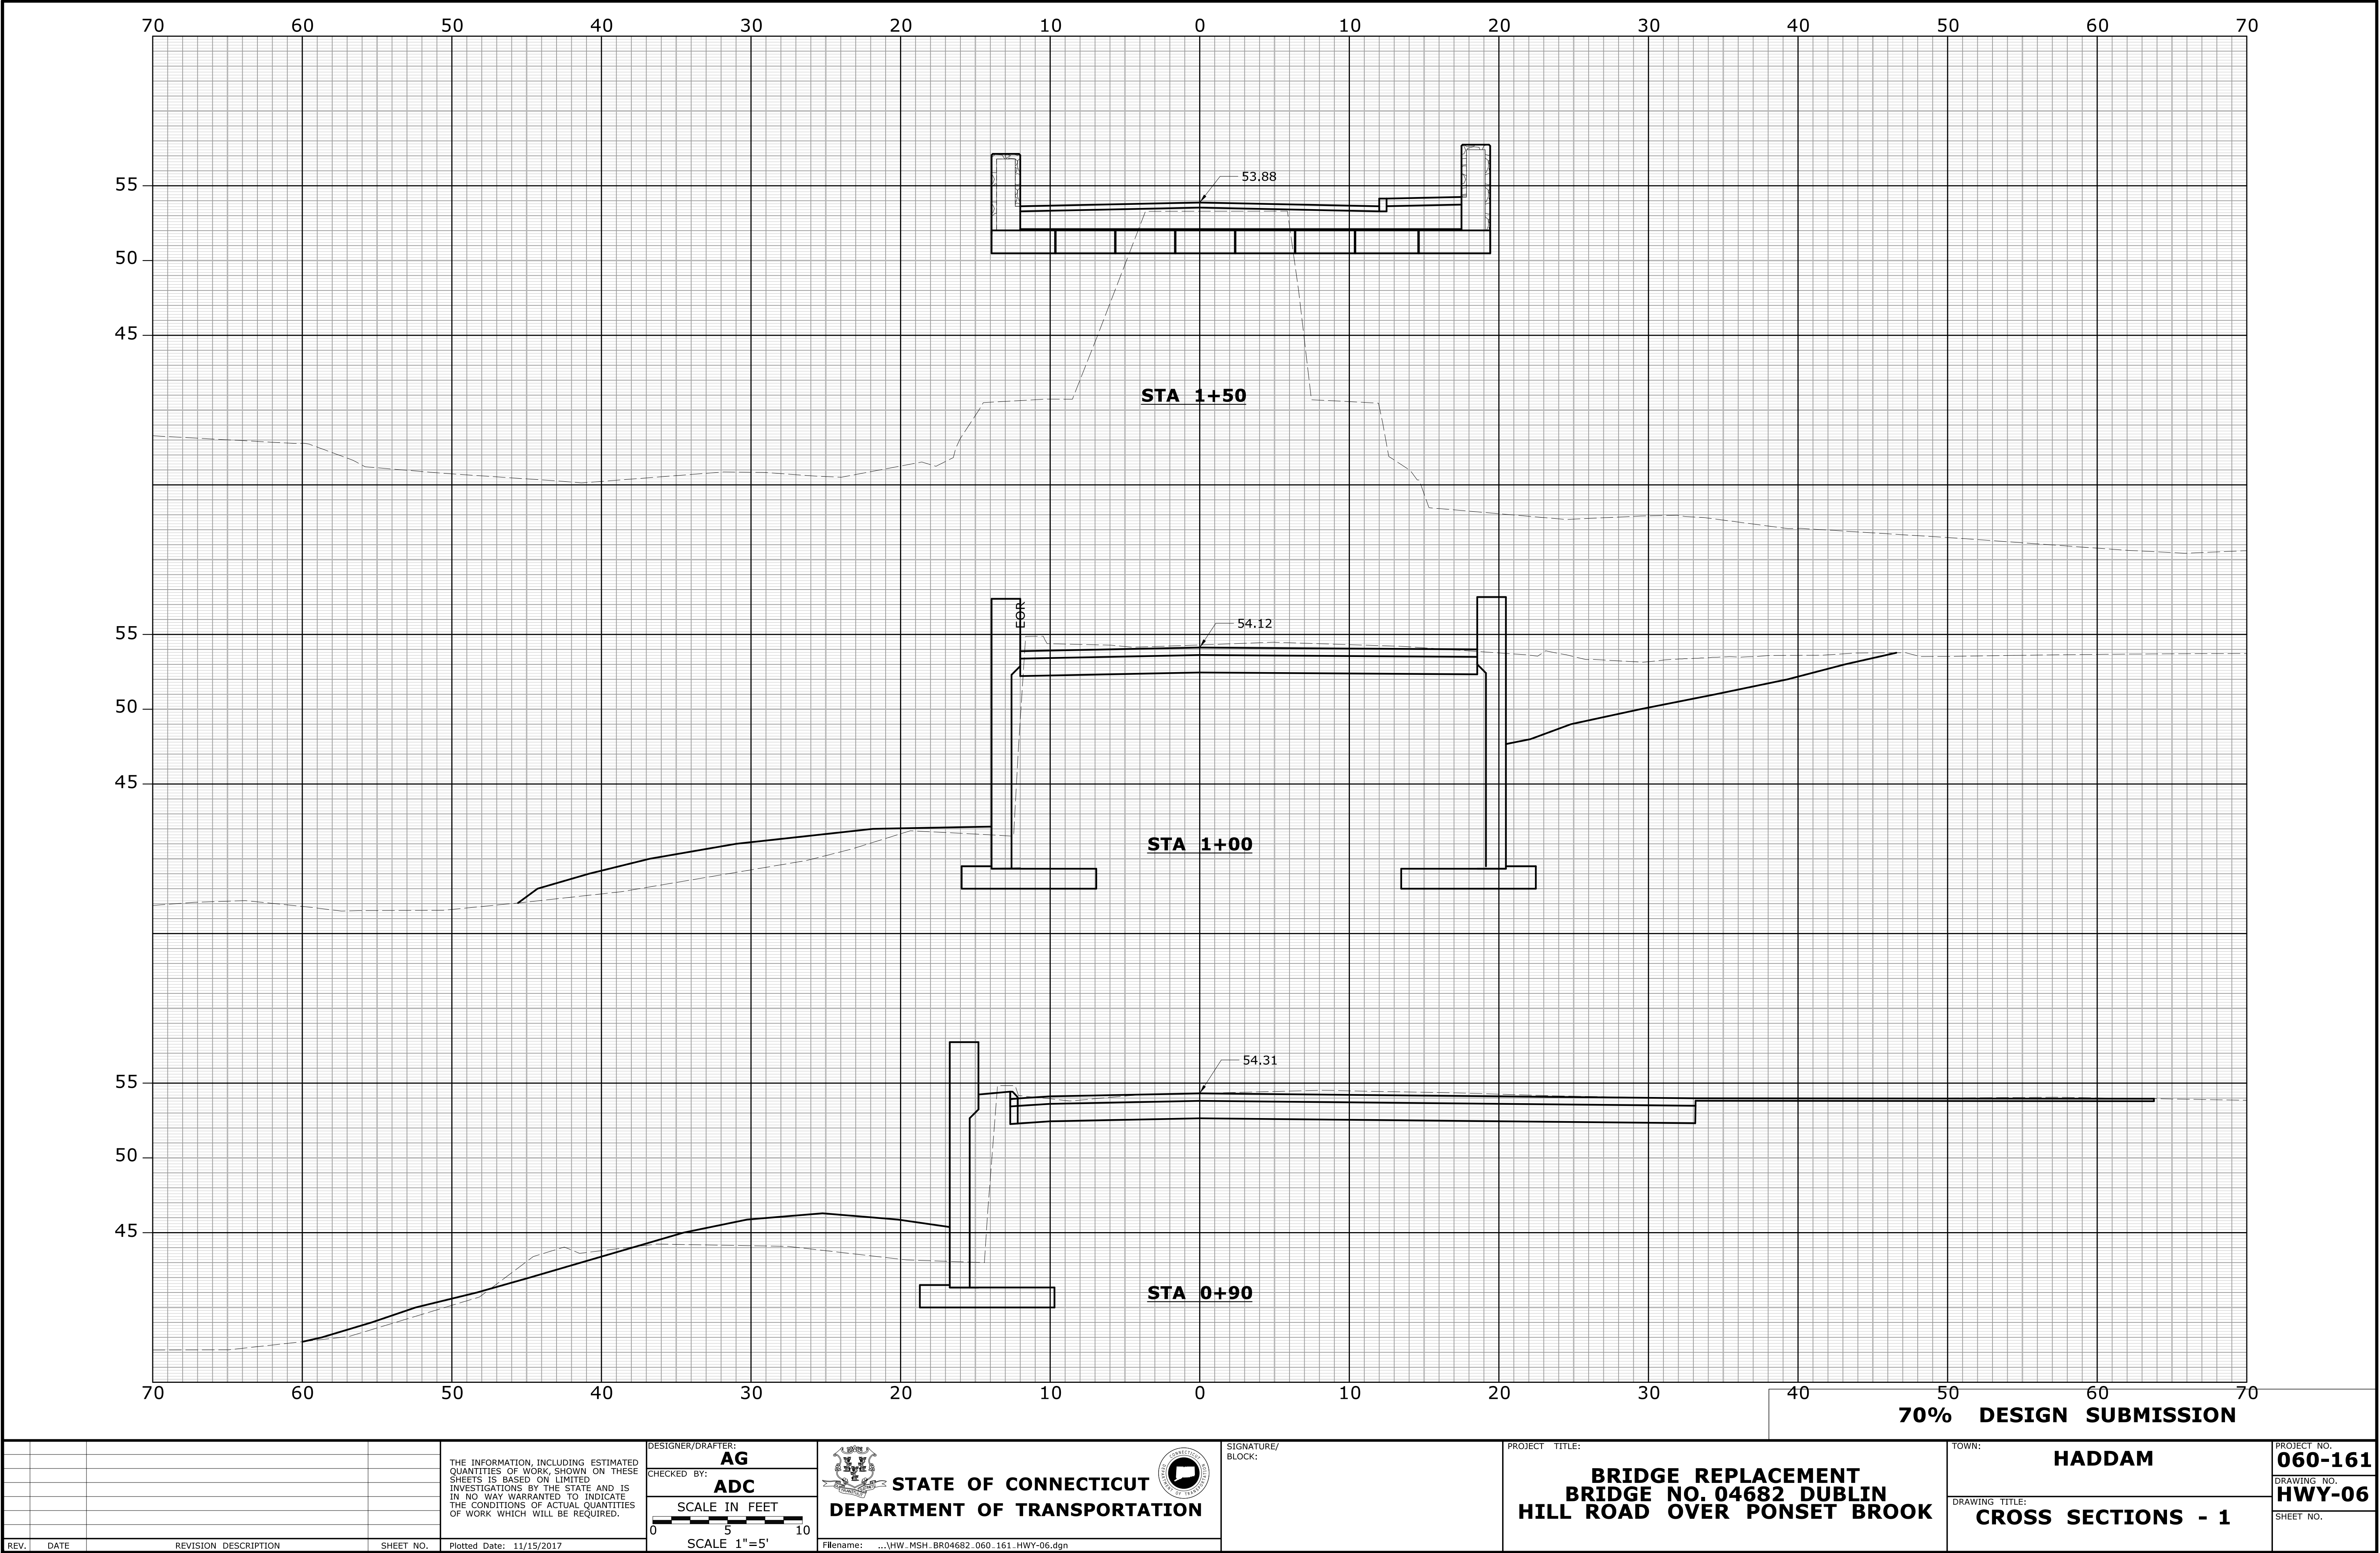SHEET NO.









				THE INFORMATION, INCLUDING ESTIMATED QUANTITIES OF WORK, SHOWN ON THESE SHEETS IS BASED ON LIMITED INVESTIGATIONS BY THE STATE AND IS IN NO WAY WARRANTED TO INDICATE THE CONDITIONS OF ACTUAL QUANTITIES OF WORK WHICH WILL BE REQUIRED.		DESIGNER/DRAFTER: <b>AG</b> CHECKED BY: <b>ADC</b> SCALE IN FEET  SCALE 1"=5'		 <b>STATE OF CONNECTICUT</b> <b>DEPARTMENT OF TRANSPORTATION</b> Filename: ...\\HW_MSH-BR04682-060-161-HWY-07.dgn		SIGNATURE/ BLOCK:		PROJECT TITLE: <b>BRIDGE REPLACEMENT</b> <b>BRIDGE NO. 04682 DUBLIN</b> <b>HILL ROAD OVER PONSET BROOK</b>		TOWN: <b>HADDAM</b>		PROJECT NO. <b>060-161</b>	
														DRAWING NO. <b>HWY-07</b>		SHEET NO.	
REV. DATE REVISION DESCRIPTION SHEET NO.				Plotted Date: 11/15/2017								DRAWING TITLE: <b>CROSS SECTIONS - 2</b>					



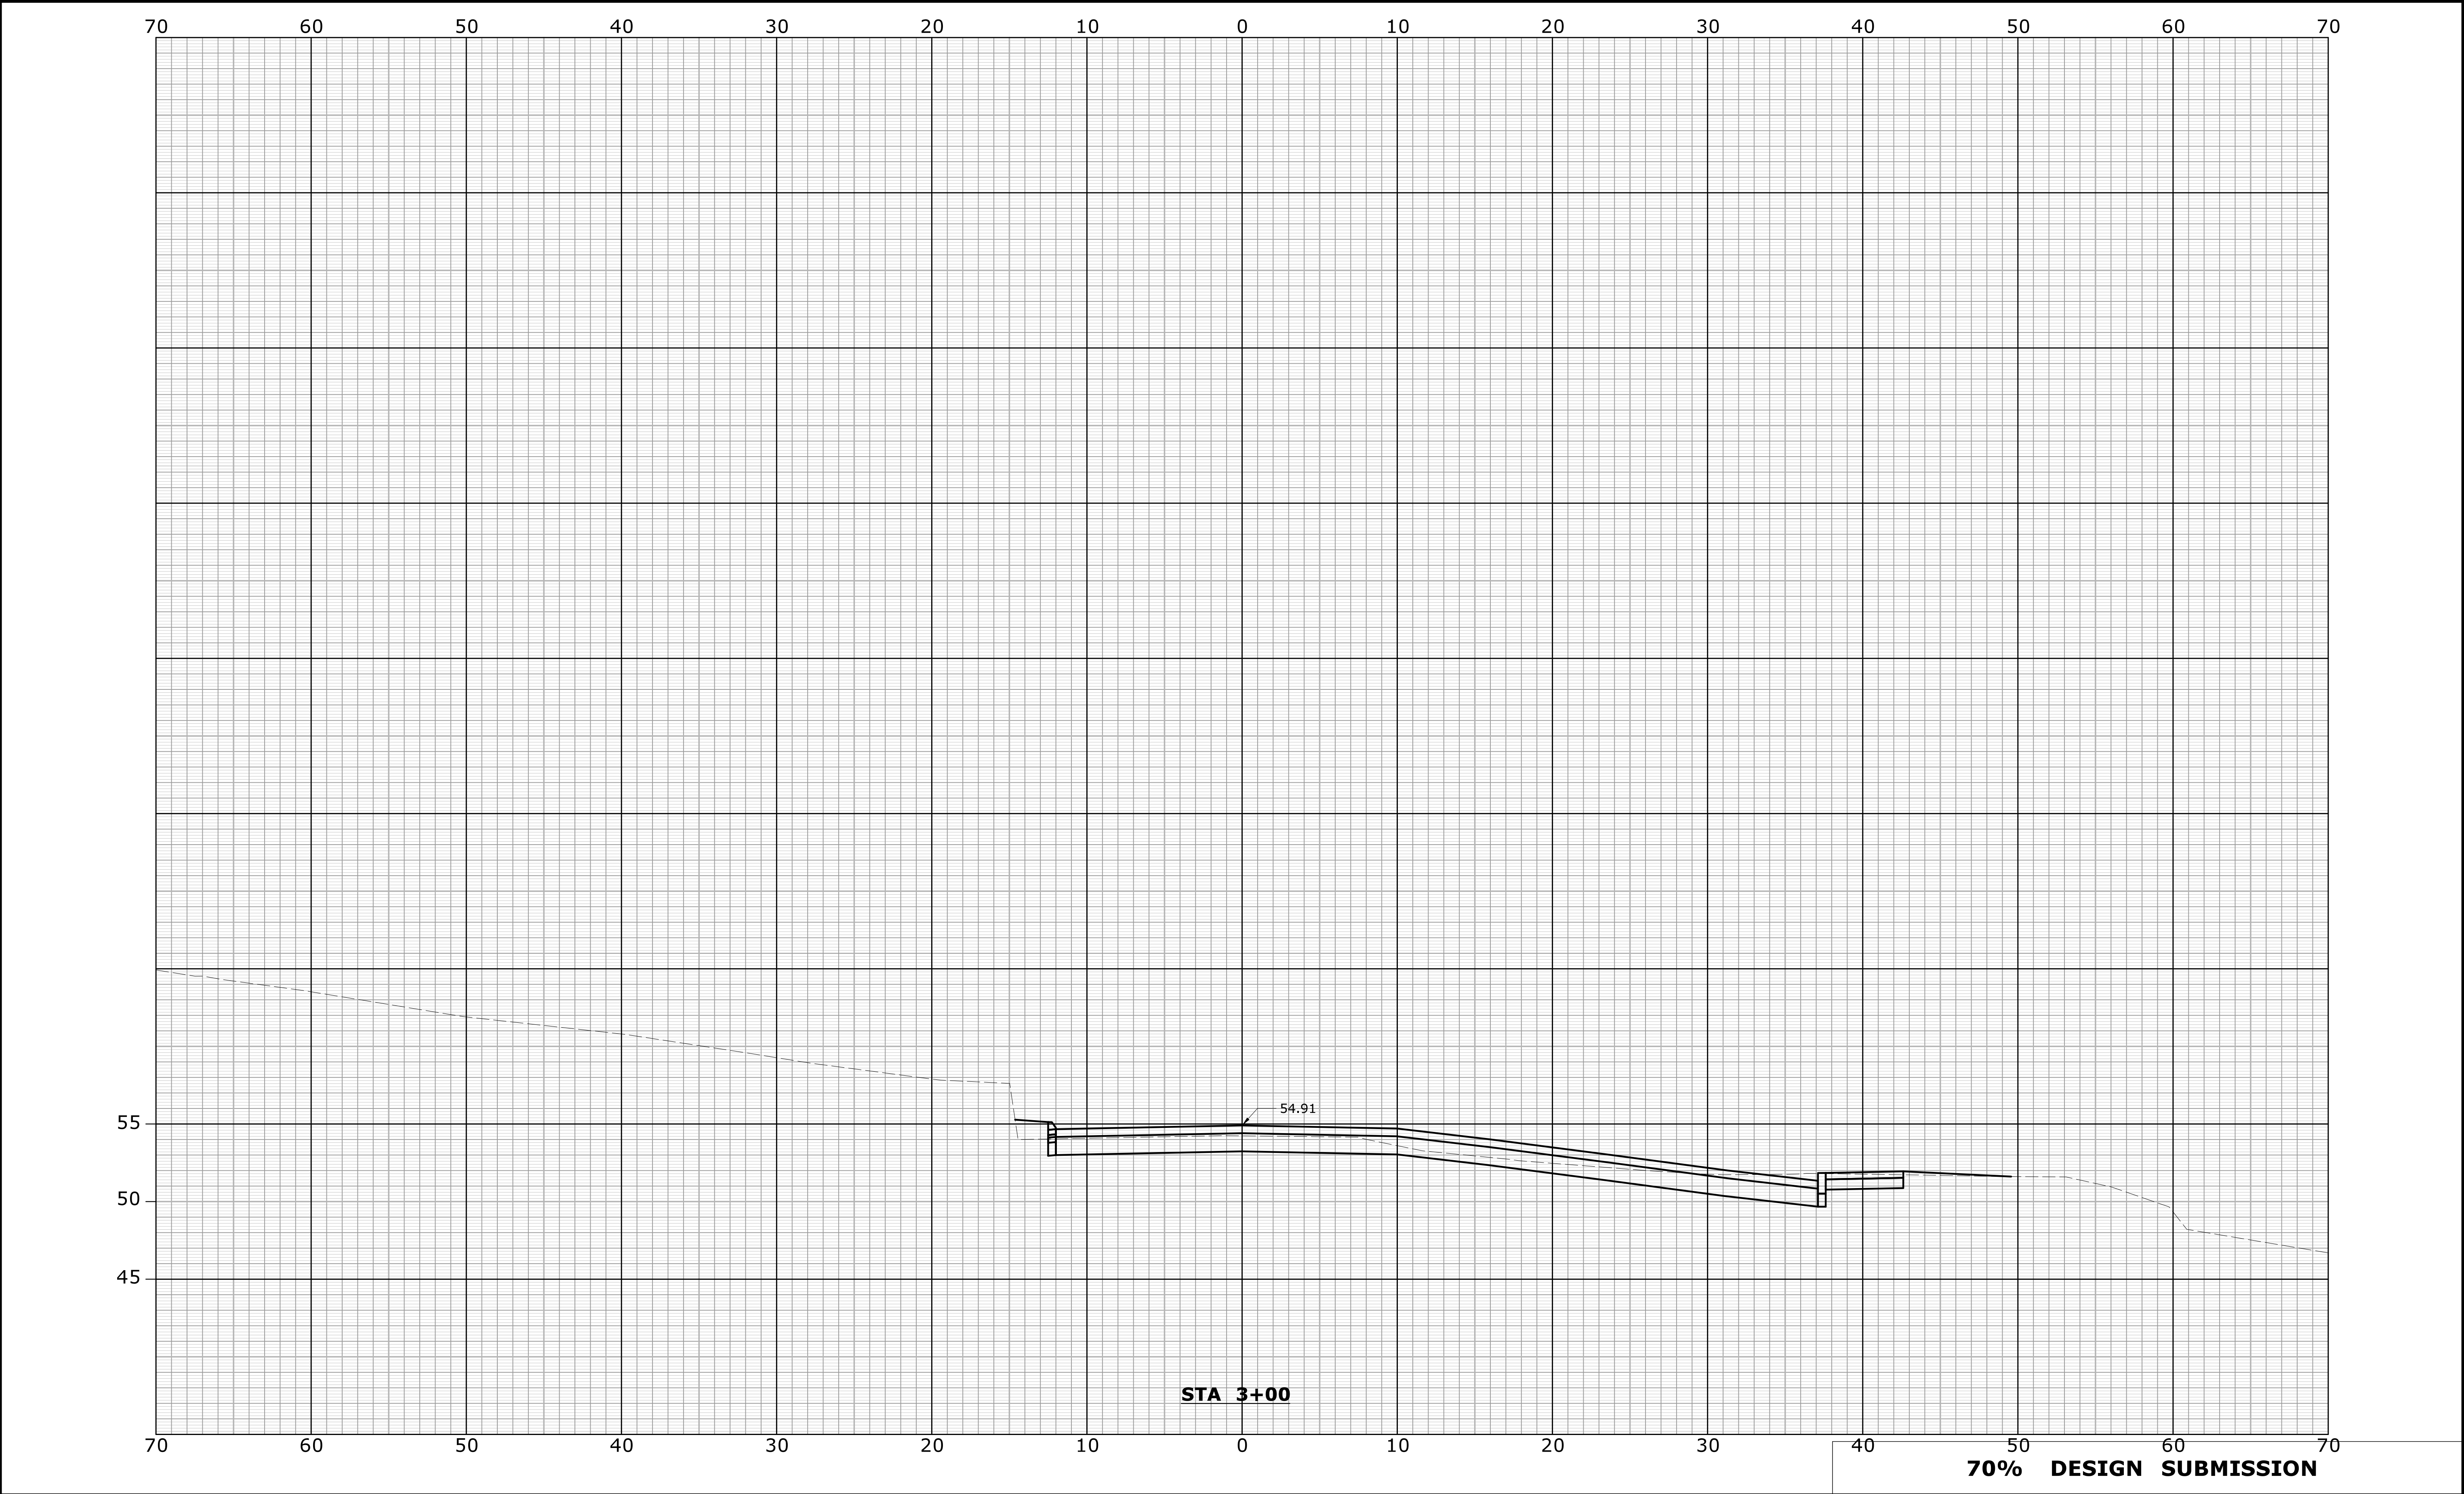


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REV.	DATE	REVISION DESCRIPTION				SHEET NO.	Plotted Date: 11/15/2017											

04 - STRUCTURE  
INDEX OF DRAWINGS


DRAWING NUMBER	DRAWING TITLE	DRAWING NUMBER	DRAWING TITLE
S-01	INDEX OF STRUCTURE		
S-02	EXISTING CONDITIONS		
S-03	GENERAL NOTES		
S-04	GENERAL PLAN		
S-05	BRIDGE ELEVATIONS AND WINGWALL SECTIONS		
S-06	BRIDGE PLAN AND SECTIONS		
S-07	STAGING PLAN		
S-08	SOIL BORING LOCATION PLAN		
S-09	SOIL BORING DATA		
S-10	SIDEWALK RAMP DETAILS		
S-11	EXISTING STRUCTURE DRAWING - 1		
S-12	EXISTING STRUCTURE DRAWING - 2		
S-13	EXISTING STRUCTURE DRAWING - 3		
S-14	EXISTING STRUCTURE DRAWING - 4		

DESIGNED BY:  
A.DICESARE ASSOCIATES, P.C.  
BRIDGEPORT, CT


70% DESIGN SUBMISSION

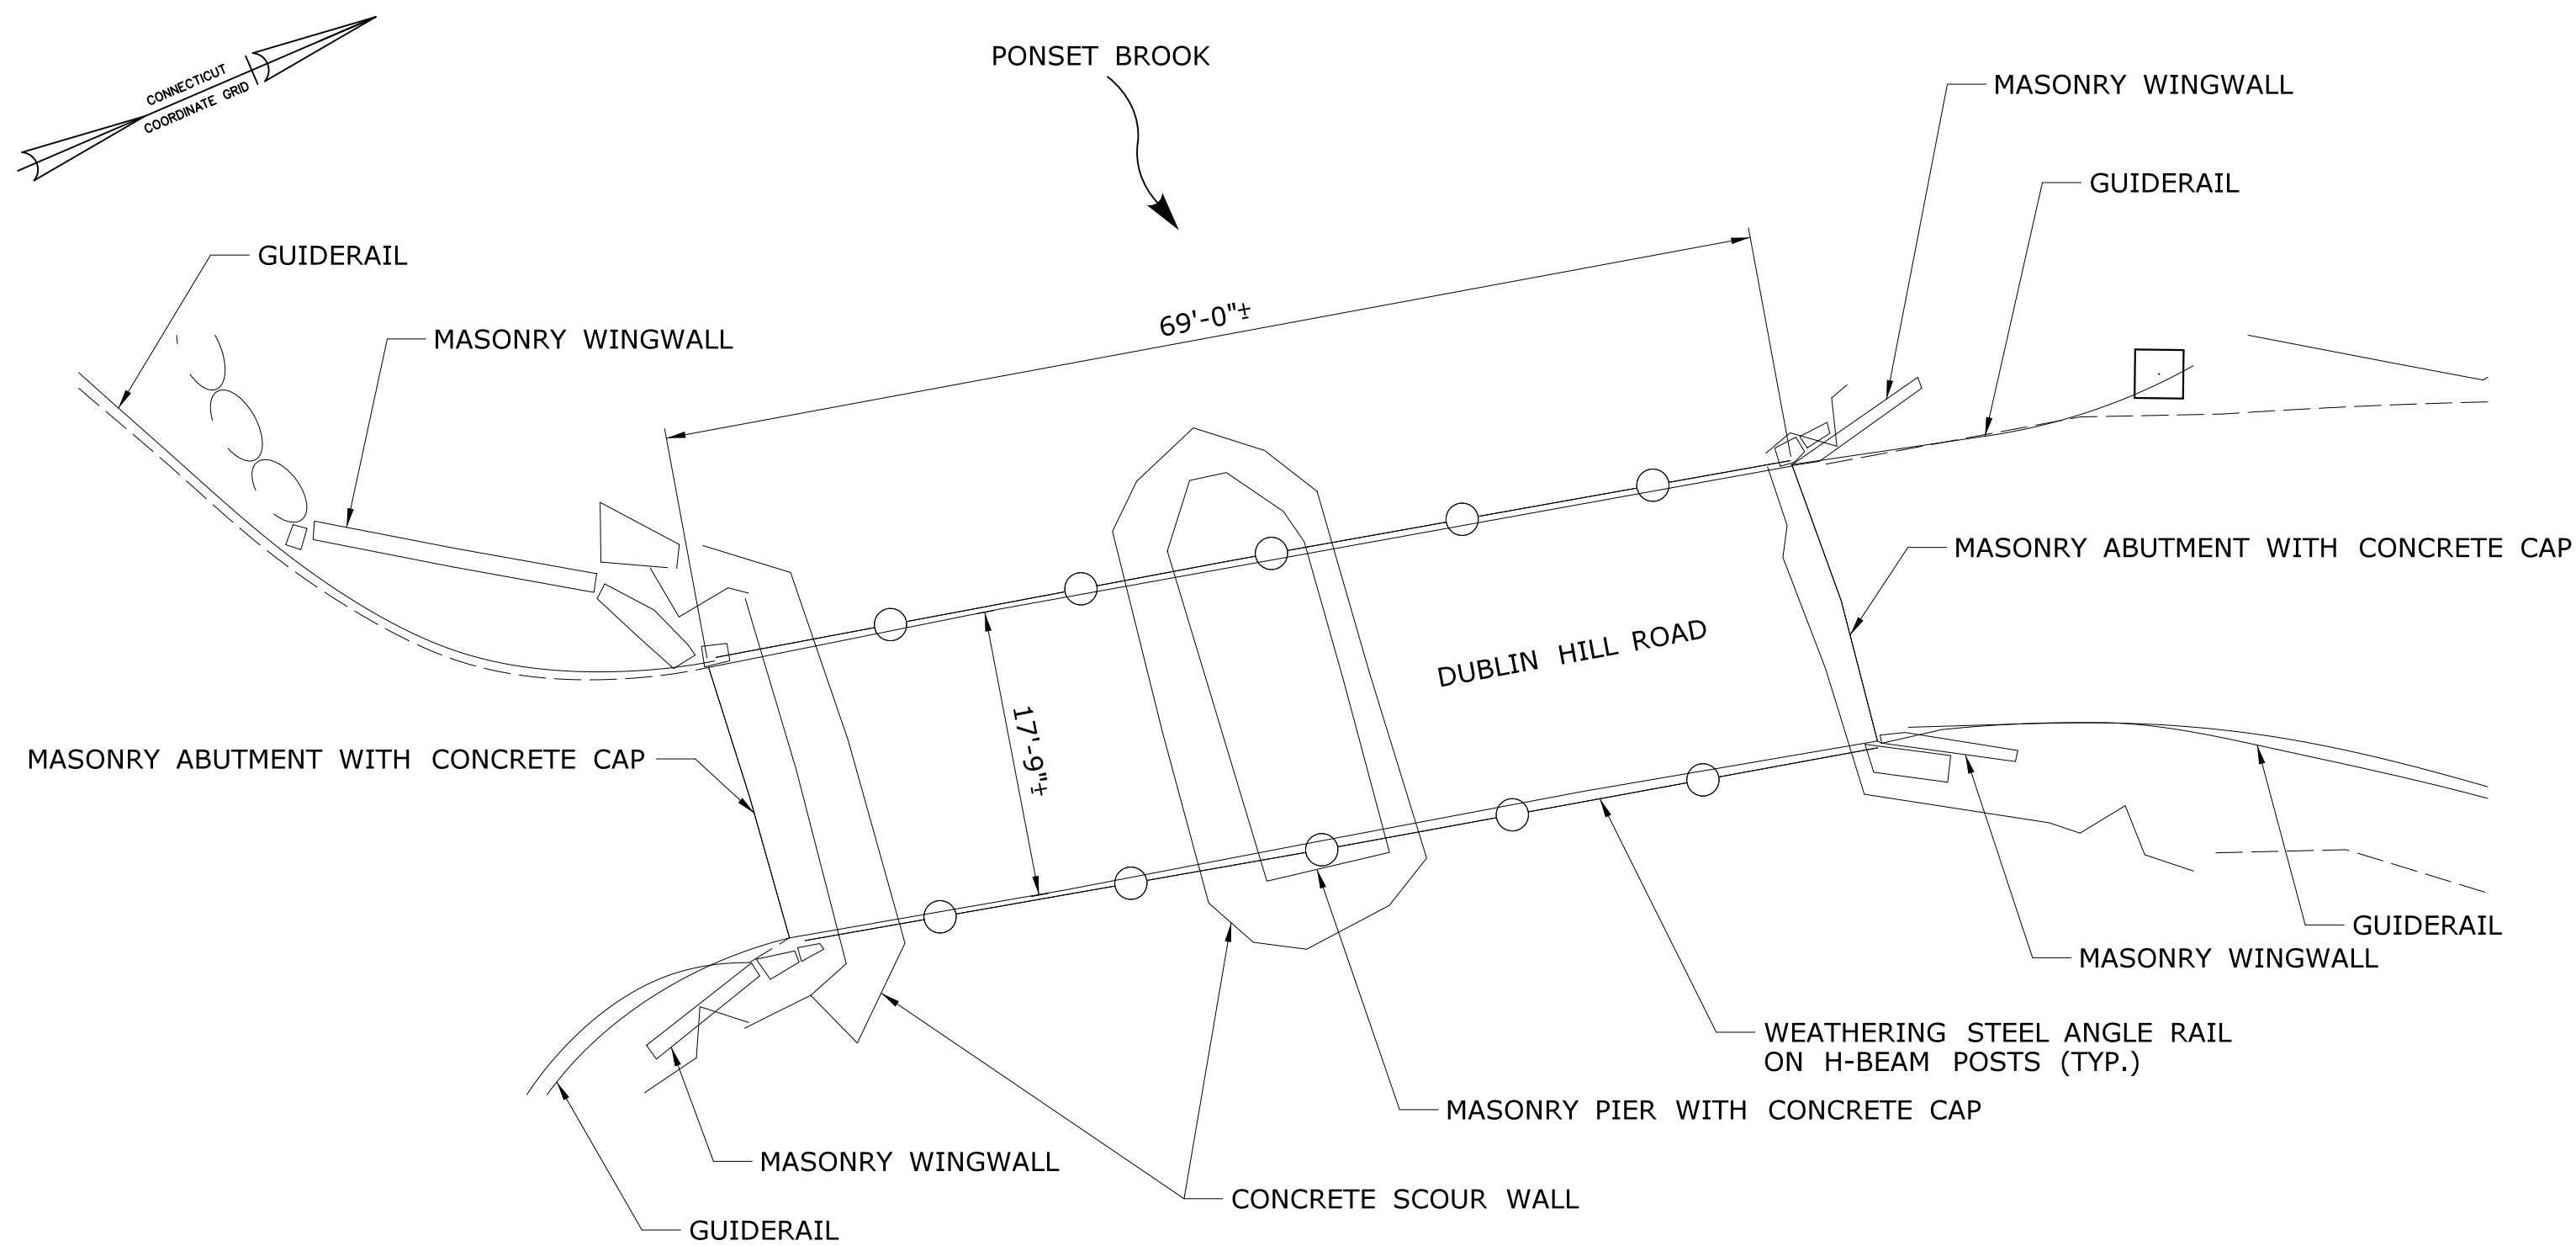

**GENERAL PLAN**  
SCALE: 1"=10'

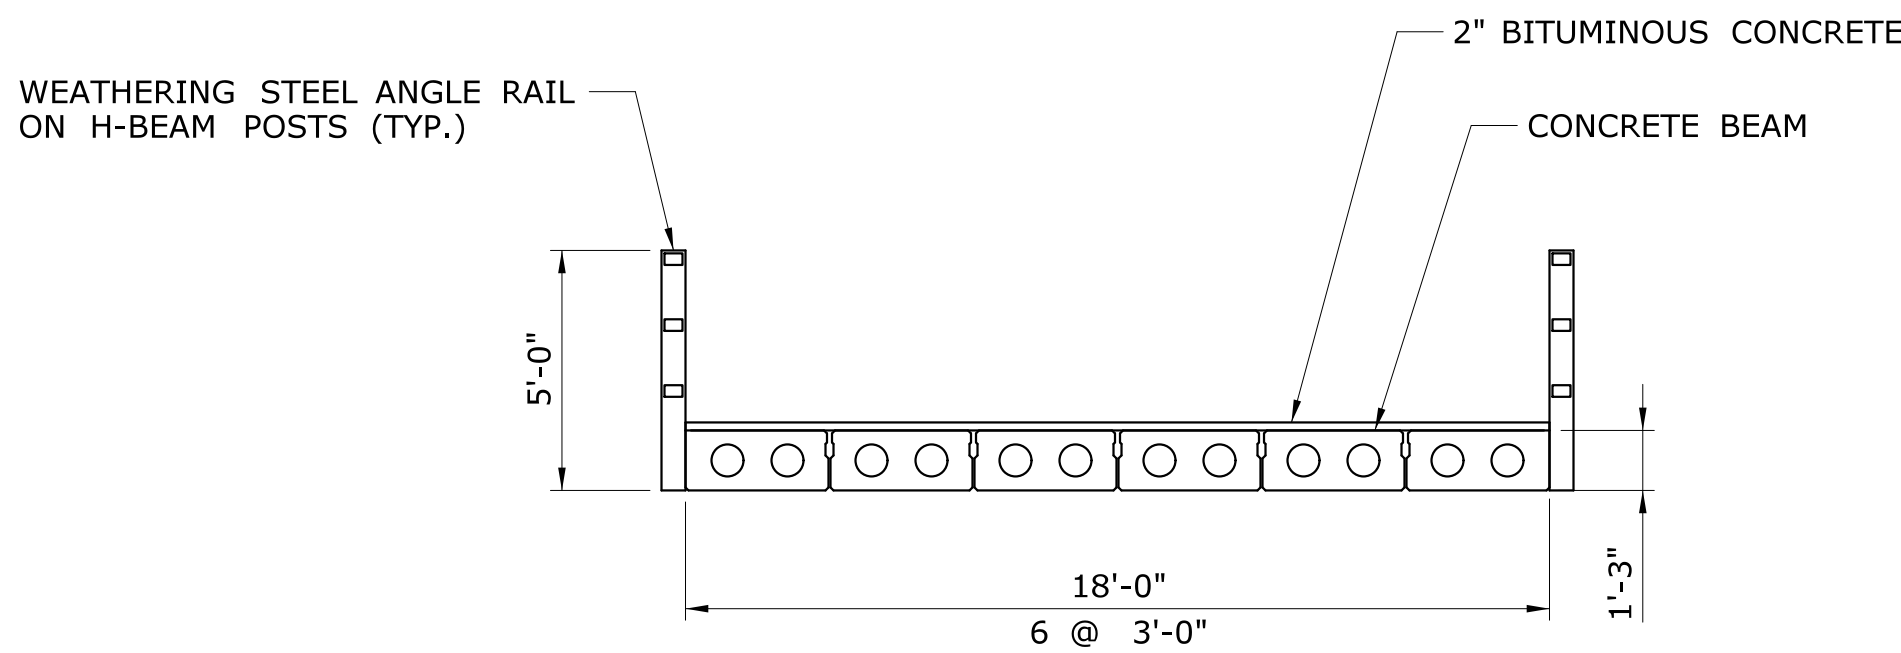

**TYPICAL CROSS SECTION**  
SCALE: 1/4"=1'-0"

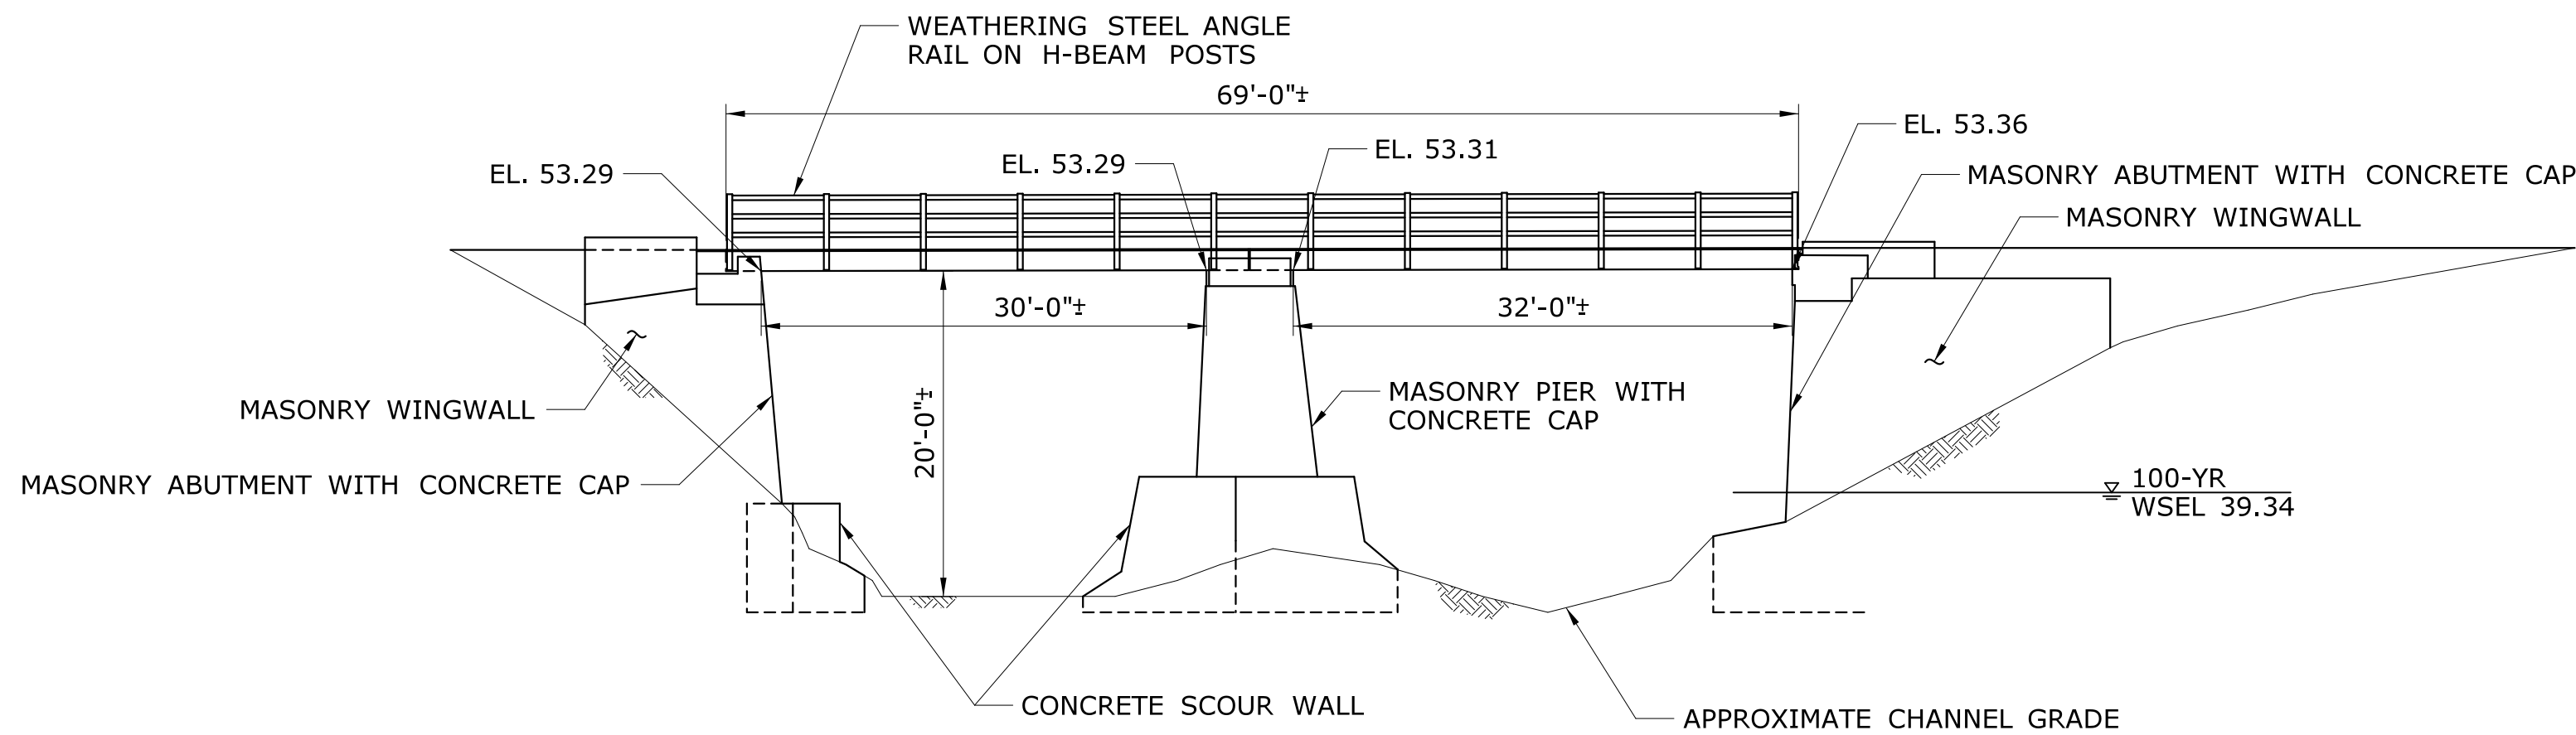

**DOWNSTREAM ELEVATION**  
SCALE: 1"=10'


**70% DESIGN SUBMISSION**


REV.	DATE	REVISION DESCRIPTION	SHEET NO.

THE INFORMATION, INCLUDING ESTIMATED QUANTITIES OF WORK, SHOWN ON THESE SHEETS IS BASED ON LIMITED INVESTIGATIONS BY THE STATE AND IS IN NO WAY WARRANTED TO INDICATE THE CONDITIONS OF ACTUAL QUANTITIES OF WORK WHICH WILL BE REQUIRED.

Plotted Date: 11/15/2017

DESIGNER/DRAFTER:  
**JK**  
CHECKED BY:  
**ADC**  
SCALE AS NOTED

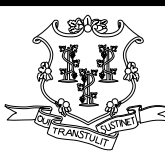**STATE OF CONNECTICUT**  
**DEPARTMENT OF TRANSPORTATION**



Filename: ...\\SB\_MSH\_Br04682\_060\_161\_S-02.dgn

SIGNATURE/  
BLOCK:

PROJECT TITLE:  
**BRIDGE REPLACEMENT  
BRIDGE NO. 04682 DUBLIN  
HILL ROAD OVER PONSET BROOK**

TOWN:  
**HADDAM**  
DRAWING TITLE:  
**EXISTING CONDITIONS**

PROJECT NO.  
**060-161**  
DRAWING NO.  
**S-02**  
SHEET NO.

NOTICE TO BRIDGE INSPECTORS	
THE DEPARTMENT'S BRIDGE SAFETY PROCEDURES REQUIRE THIS BRIDGE TO BE INSPECTED FOR, BUT NOT LIMITED TO, ALL APPROPRIATE COMPONENTS INDICATED IN THE GOVERNING MANUALS FOR BRIDGE INSPECTION. ATTENTION MUST BE GIVEN TO INSPECTING THE FOLLOWING SPECIAL COMPONENTS AND DETAILS. (THE LISTING OF COMPONENTS FOR SPECIFIC ATTENTION SHALL NOT BE CONSTRUED TO REDUCE THE IMPORTANCE OF ANY OTHER COMPONENT OF THE STRUCTURE.) THE FREQUENCY OF INSPECTION OF THIS STRUCTURE SHALL BE IN ACCORDANCE WITH THE GOVERNING MANUALS FOR BRIDGE INSPECTION, UNLESS OTHERWISE DIRECTED BY THE MANAGER OF BRIDGE SAFETY AND EVALUATION.	
COMPONENT OR DETAIL	DRAWING NUMBER REFERENCE
NONE	-

TABLE OF QUANTITIES		
ITEM	UNIT	QUANTITY
STRUCTURE EXCAVATION - EARTH (EXCLUDING COFFERDAM & DEWATERING)	CY	1,300
STRUCTURE EXCAVATION - ROCK (EXCLUDING COFFERDAM & DEWATERING)	CY	85
HANDLING WATER	LS	LS
PREVIOUS STRUCTURE BACKFILL	CY	630
REMOVAL OF SUPERSTRUCTURE	LS	LS
PRECAST REINFORCED ARCH	LF	33
CLASS "A" CONCRETE	CY	190
CONCRETE FORM LINER	SF	1,700
CLASS "F" CONCRETE	CY	70
DEFORMED STEEL BARS	LB	7,700
DEFORMED STEEL BARS - EPOXY COATED	LB	9,100
DRILLING AND GROUTING REINFORCING BARS	LF	400
MEMBRANE WATERPROOFING (COLD LIQUID ELASTOMERIC)	SY	366
DAMPROOFING	SY	190
REMOVAL OF EXISTING MASONRY	CY	638

MAXIMUM COMPONENT SIZE CHARACTERISTICS
(SOUTH ABUTMENT TO SPLICE)
LENGTH = XXX
WIDTH = XXX
HEIGHT = XXX
WEIGHT = XXX

TRANSPORTATION DATA (APPROXIMATE MAXIMUM ESTIMATED VALUES)				
MEMBER	SHIPPING LENGTH	SHIPPING HEIGHT	SHIPPING WIDTH	SHIPPING WEIGHT
TYP.	XXXX.XX	XXXX.XX	XXXX.XX	XXXX.XX

CONCRETE DISTRIBUTION		
SUPERSTRUCTURE	C.Y.	XXX
SUBSTRUCTURE	C.Y.	XXX
FOOTINGS	C.Y.	XXX
TOTAL	C.Y.	XXX

BRIDGE IDENTIFICATION PLACARDS: THE CONTRACTOR SHALL PROVIDE AND INSTALL NEW BRIDGE IDENTIFICATION SIGNS AT THE LEADING END OF EACH BRIDGE PARAPET ON THE TRAFFIC SIDE. THE SIGNS SHALL BE FABRICATED WITH 40 GAUGE ALUMINUM SHEET METAL. THE SIGNS SHALL BE 4" X 12" WITH 3" WHITE REFLECTIVE BLOCK LETTERS ON GREEN REFLECTIVE SHEETING. EACH SIGN SHALL READ: 04682. ALL COSTS ASSOCIATED WITH PROVIDING AND INSTALLING THE BRIDGE SIGNS SHALL BE COVERED UNDER ITEM 1208928 SIGN FACE SHEET ALUMINUM (TYPE IV REFLECTIVE SHEETING). THE FINAL LOCATION AND ATTACHMENT METHOD FOR THE SIGNS SHALL BE APPROVED BY THE ENGINEER PRIOR TO INSTALLATION.

GENERAL NOTES

SPECIFICATIONS: CONNECTICUT DEPARTMENT OF TRANSPORTATION FORM 817 (2016), SUPPLEMENTAL SPECIFICATIONS DATED JULY 2017 AND SPECIAL PROVISIONS.

DESIGN SPECIFICATIONS: AASHTO LRFD BRIDGE DESIGN SPECIFICATIONS (4TH EDITION) AS SUPPLEMENTED BY THE CONNECTICUT DEPARTMENT OF TRANSPORTATION BRIDGE DESIGN MANUAL (2003).

ALLOWABLE DESIGN STRESSES:  
-CLASS "A" BASED ON f'c = 3,300 P.S.I.  
-CLASS "F" BASED ON f'c = 4,400 P.S.I.  
-REINFORCEMENT: (ASTM A615 GRADE 60) fy = 60,000 P.S.I.

THE SPECIFIED CONCRETE STRENGTH USED IN DESIGN, f'c, OF THE CONCRETE COMPONENTS IS NOTED ABOVE. THE MINIMUM COMPRESSIVE STRENGTH OF THE CONCRETE IN THE CONSTRUCTED COMPONENTS SHALL CONFORM TO THE REQUIREMENTS OF THE SPECIAL PROVISION "SECTION 6.01 CONCRETE FOR STRUCTURES."

HMA OVERLAY: OVERLAY SHALL CONSIST OF 6" HMA S0.5 ON 14" SUBBASE ON PERVIOUS STRUCTURE BACKFILL ON 3" SAND ON MEMBRANE WATERPROOFING.

LIVE LOAD: HL-93

FUTURE PAVING ALLOWANCES: NONE

DIMENSIONS: WHEN DIMENSIONS ARE GIVEN TO LESS THAN THREE DECIMAL PLACES, THE OMITTED DIGITS SHALL BE ASSUMED TO BE ZERO.

EXISTING DIMENSIONS: DIMENSIONS OF THE EXISTING STRUCTURE SHOWN ON THESE PLANS ARE FOR GENERAL REFERENCE ONLY. THE CONTRACTOR SHALL TAKE ALL FIELD MEASUREMENTS NECESSARY TO ASSURE PROPER FIT OF THE FINISHED WORK AND SHALL ASSUME FULL RESPONSIBILITY FOR THEIR ACCURACY. WHEN SHOP DRAWINGS BASED ON FIELD MEASUREMENTS ARE SUBMITTED FOR APPROVAL, THE FIELD MEASUREMENTS SHALL ALSO BE SUBMITTED FOR REFERENCE BY THE REVIEWER.

SUPERSTRUCTURE REMOVAL: BEFORE INITIATING CONSTRUCTION, CONTRACTOR SHALL SUBMIT A PLAN FOR APPROVAL DEFINING METHOD FOR CONSTRUCTION AND PROTECTION OF DEBRIS FROM FALLING INTO THE STREAMBED DURING REMOVAL OF THE EXISTING BRIDGE SUPERSTRUCTURE. COST TO BE INCLUDED IN THE COST OF "REMOVAL OF SUPERSTRUCTURE".

TRAFFIC: ALL WORK SHALL BE DONE IN ACCORDANCE WITH THE SPECIAL PROVISIONS FOR "MAINTENANCE AND PROTECTION OF TRAFFIC" AND "SECTION 1.08 - PROSECUTION AND PROGRESS."

CONCRETE NOTES

CLASS "A" CONCRETE: CLASS "A" CONCRETE SHALL BE USED FOR ABUTMENTS AND WINGWALL FOOTINGS.

CLASS "F" CONCRETE: CLASS "F" CONCRETE SHALL BE USED FOR SIDEWALKS, PARAPETS AND WINGWALL STEMS.

EXPOSED EDGES: EXPOSED EDGES OF CONCRETE SHALL BE BEVELED 1" X 1" UNLESS DIMENSIONED OTHERWISE.

CONCRETE COVER: ALL REINFORCEMENT SHALL HAVE MIN. 2" COVER UNLESS DIMENSIONED OTHERWISE.

REINFORCEMENT: ALL REINFORCEMENT SHALL BE ASTM A615 GRADE 60. THESE PLANS ARE DETAILED WITH ENGLISH DESIGNATION OF REINFORCING. THE DESIGNATION IS BASED ON THE DIAMETER OF THE BAR IN INCHES.

REINFORCING BARS: ALL REINFORCEMENT IN THE ABUTMENTS AND WINGWALL FOOTINGS SHALL BE BLACK BARS UNLESS OTHERWISE NOTED.

ALL REINFORCEMENT IN THE PRECAST REINFORCED CONCRETE ARCH SHALL BE INCLUDED IN THE COST OF THE ITEM "PRECAST REINFORCED CONCRETE ARCH".



EPOXY COATED REINFORCING BARS: ALL REINFORCEMENT IN THE SIDEWALKS, WINGWALL STEMS AND PARAPETS SHALL BE EPOXY COATED UNLESS NOTED OTHERWISE. THESE BARS SHALL BE PAID FOR UNDER THE ITEM "DEFORMED STEEL BARS (EPOXY COATED)".

CONSTRUCTION JOINTS: CONSTRUCTION JOINTS, OTHER THAN THOSE SHOWN ON PLANS, WILL NOT BE PERMITTED WITHOUT THE PRIOR APPROVAL OF THE ENGINEER.


70% DESIGN SUBMISSION

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70% DESIGN SUBMISSION

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						CHECKED BY: <b>ADC</b>		DRAWING NO. <b>S-04</b>											
						SCALE AS NOTED		SHEET NO.											
REV.	DATE	REVISION DESCRIPTION		SHEET NO.	Plotted Date: 11/15/2017				Filename: ...\\SB_MSH_Br04682_060_161_S-04.dgn										

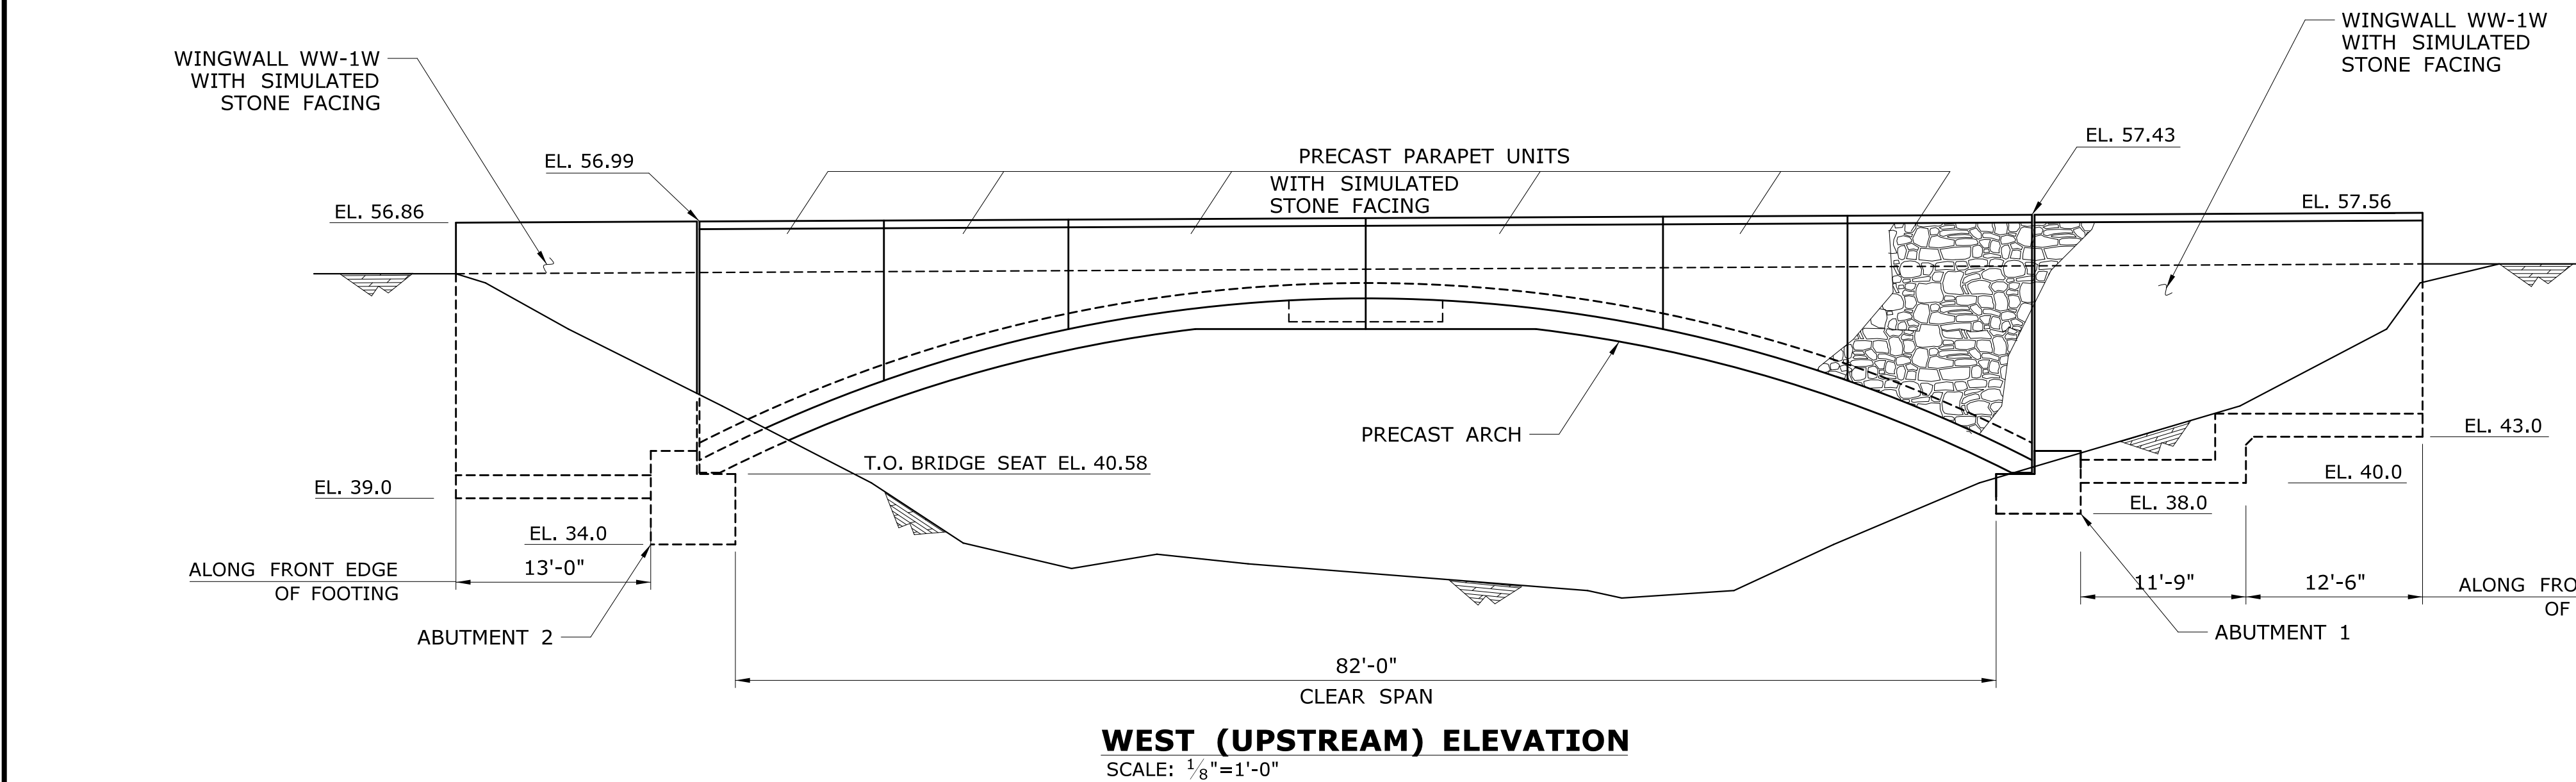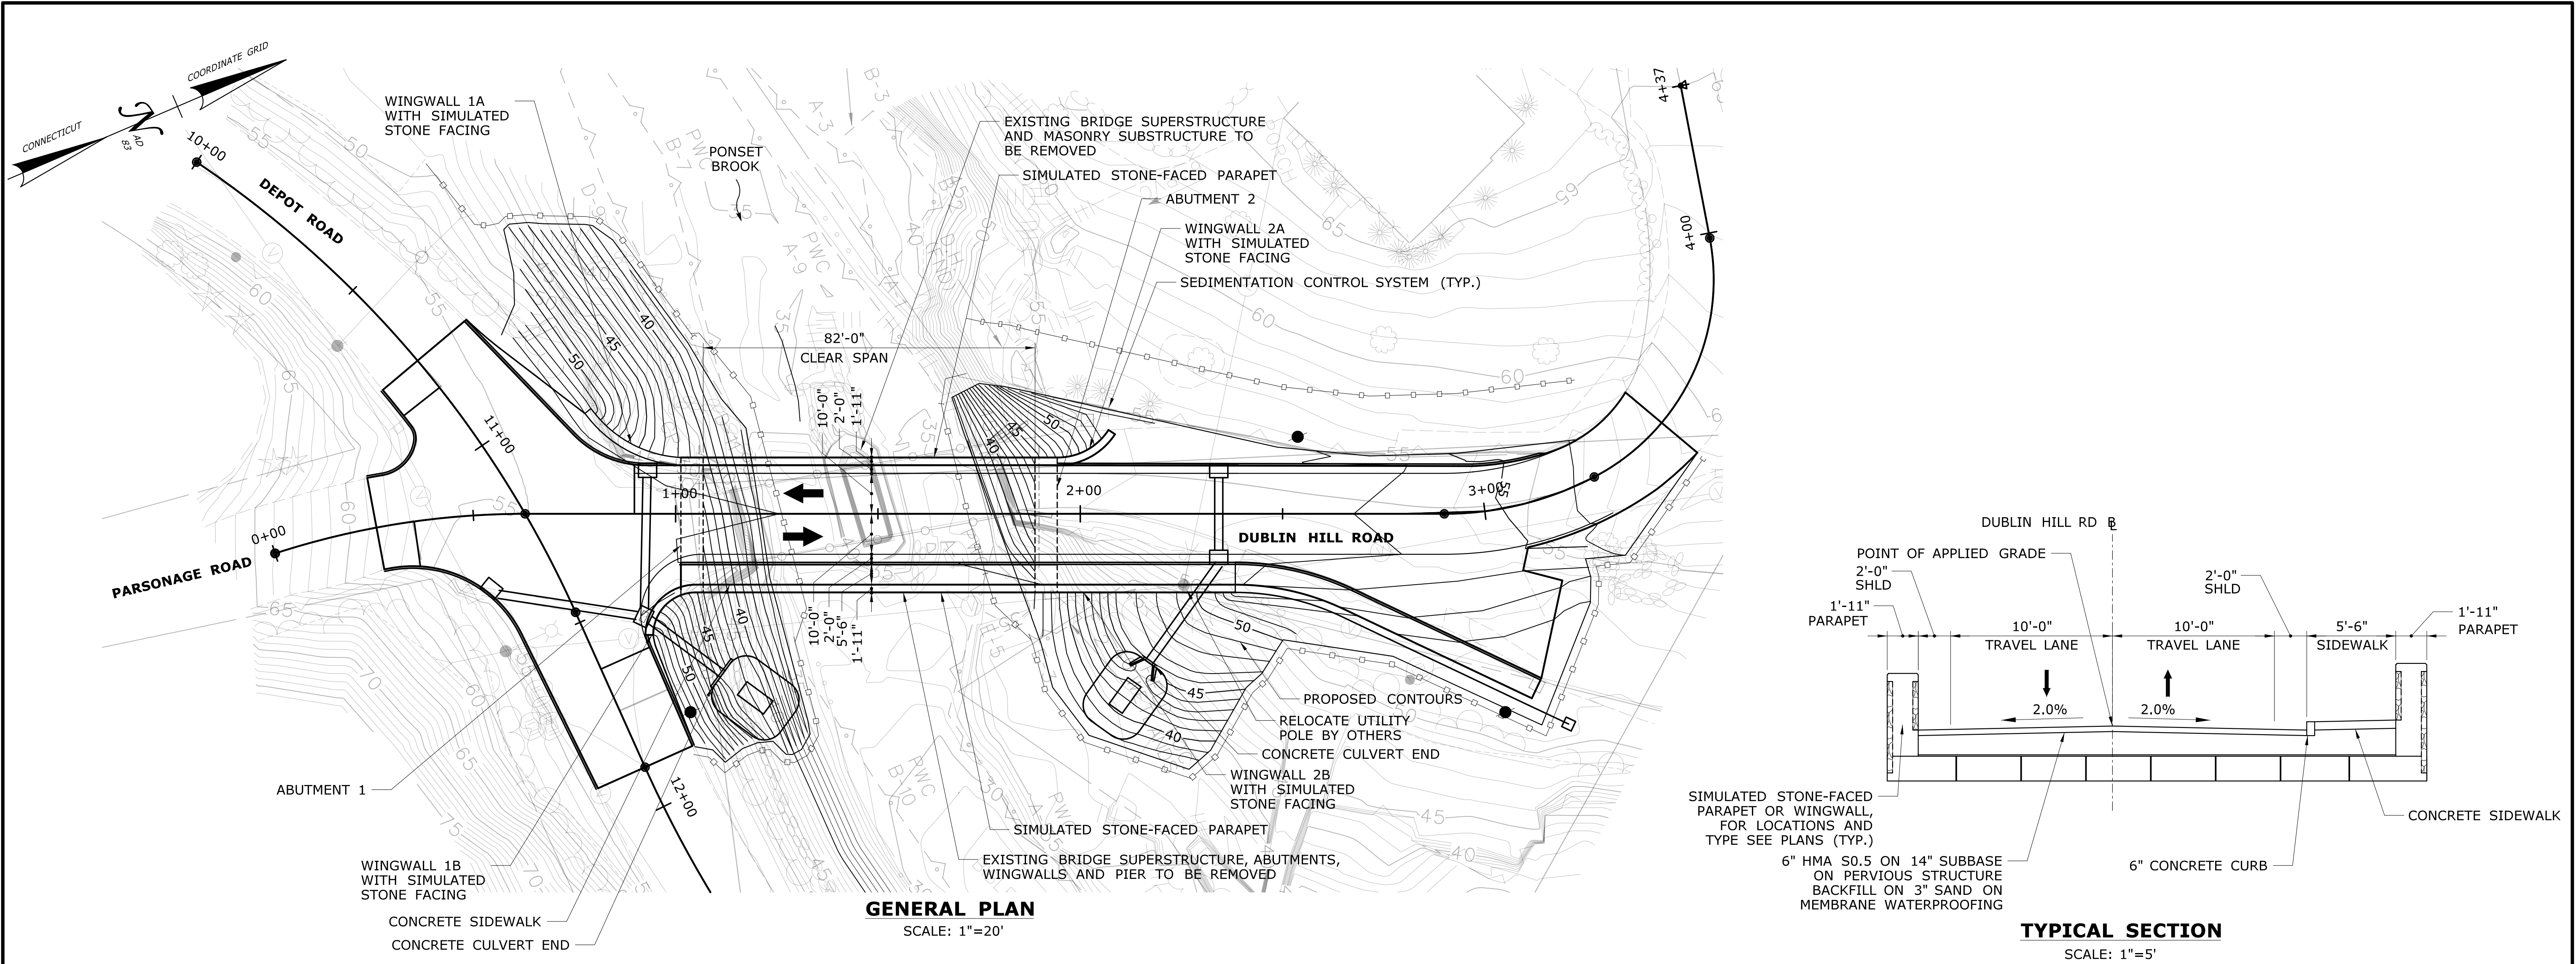

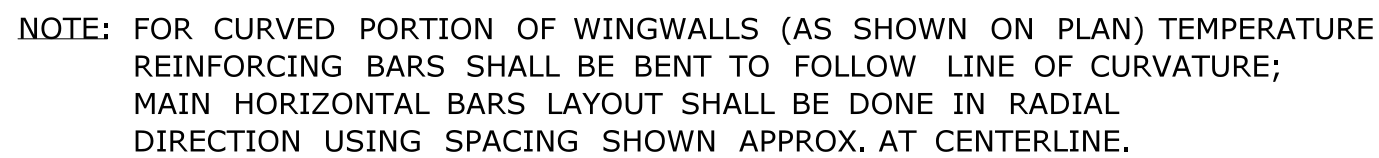



Diagram showing four circles, each containing a number above a horizontal line and a minus sign below the line:


5	6	7	8
-	-	-	-

WINGWALL SCHEDULE				
SECTION	A	B	(1)	(2)
5	10'-0"	1'-10"	#7@12"	#6@8"
6	9'-0"	1'-10"	#6@12"	#6@10"
7	8'-0"	1'-6"	#6@14"	#6@12"
8	7'-0"	1'-6"	#5@12"	#5@12"


## 70% DESIGN SUBMISSION

[illegible]

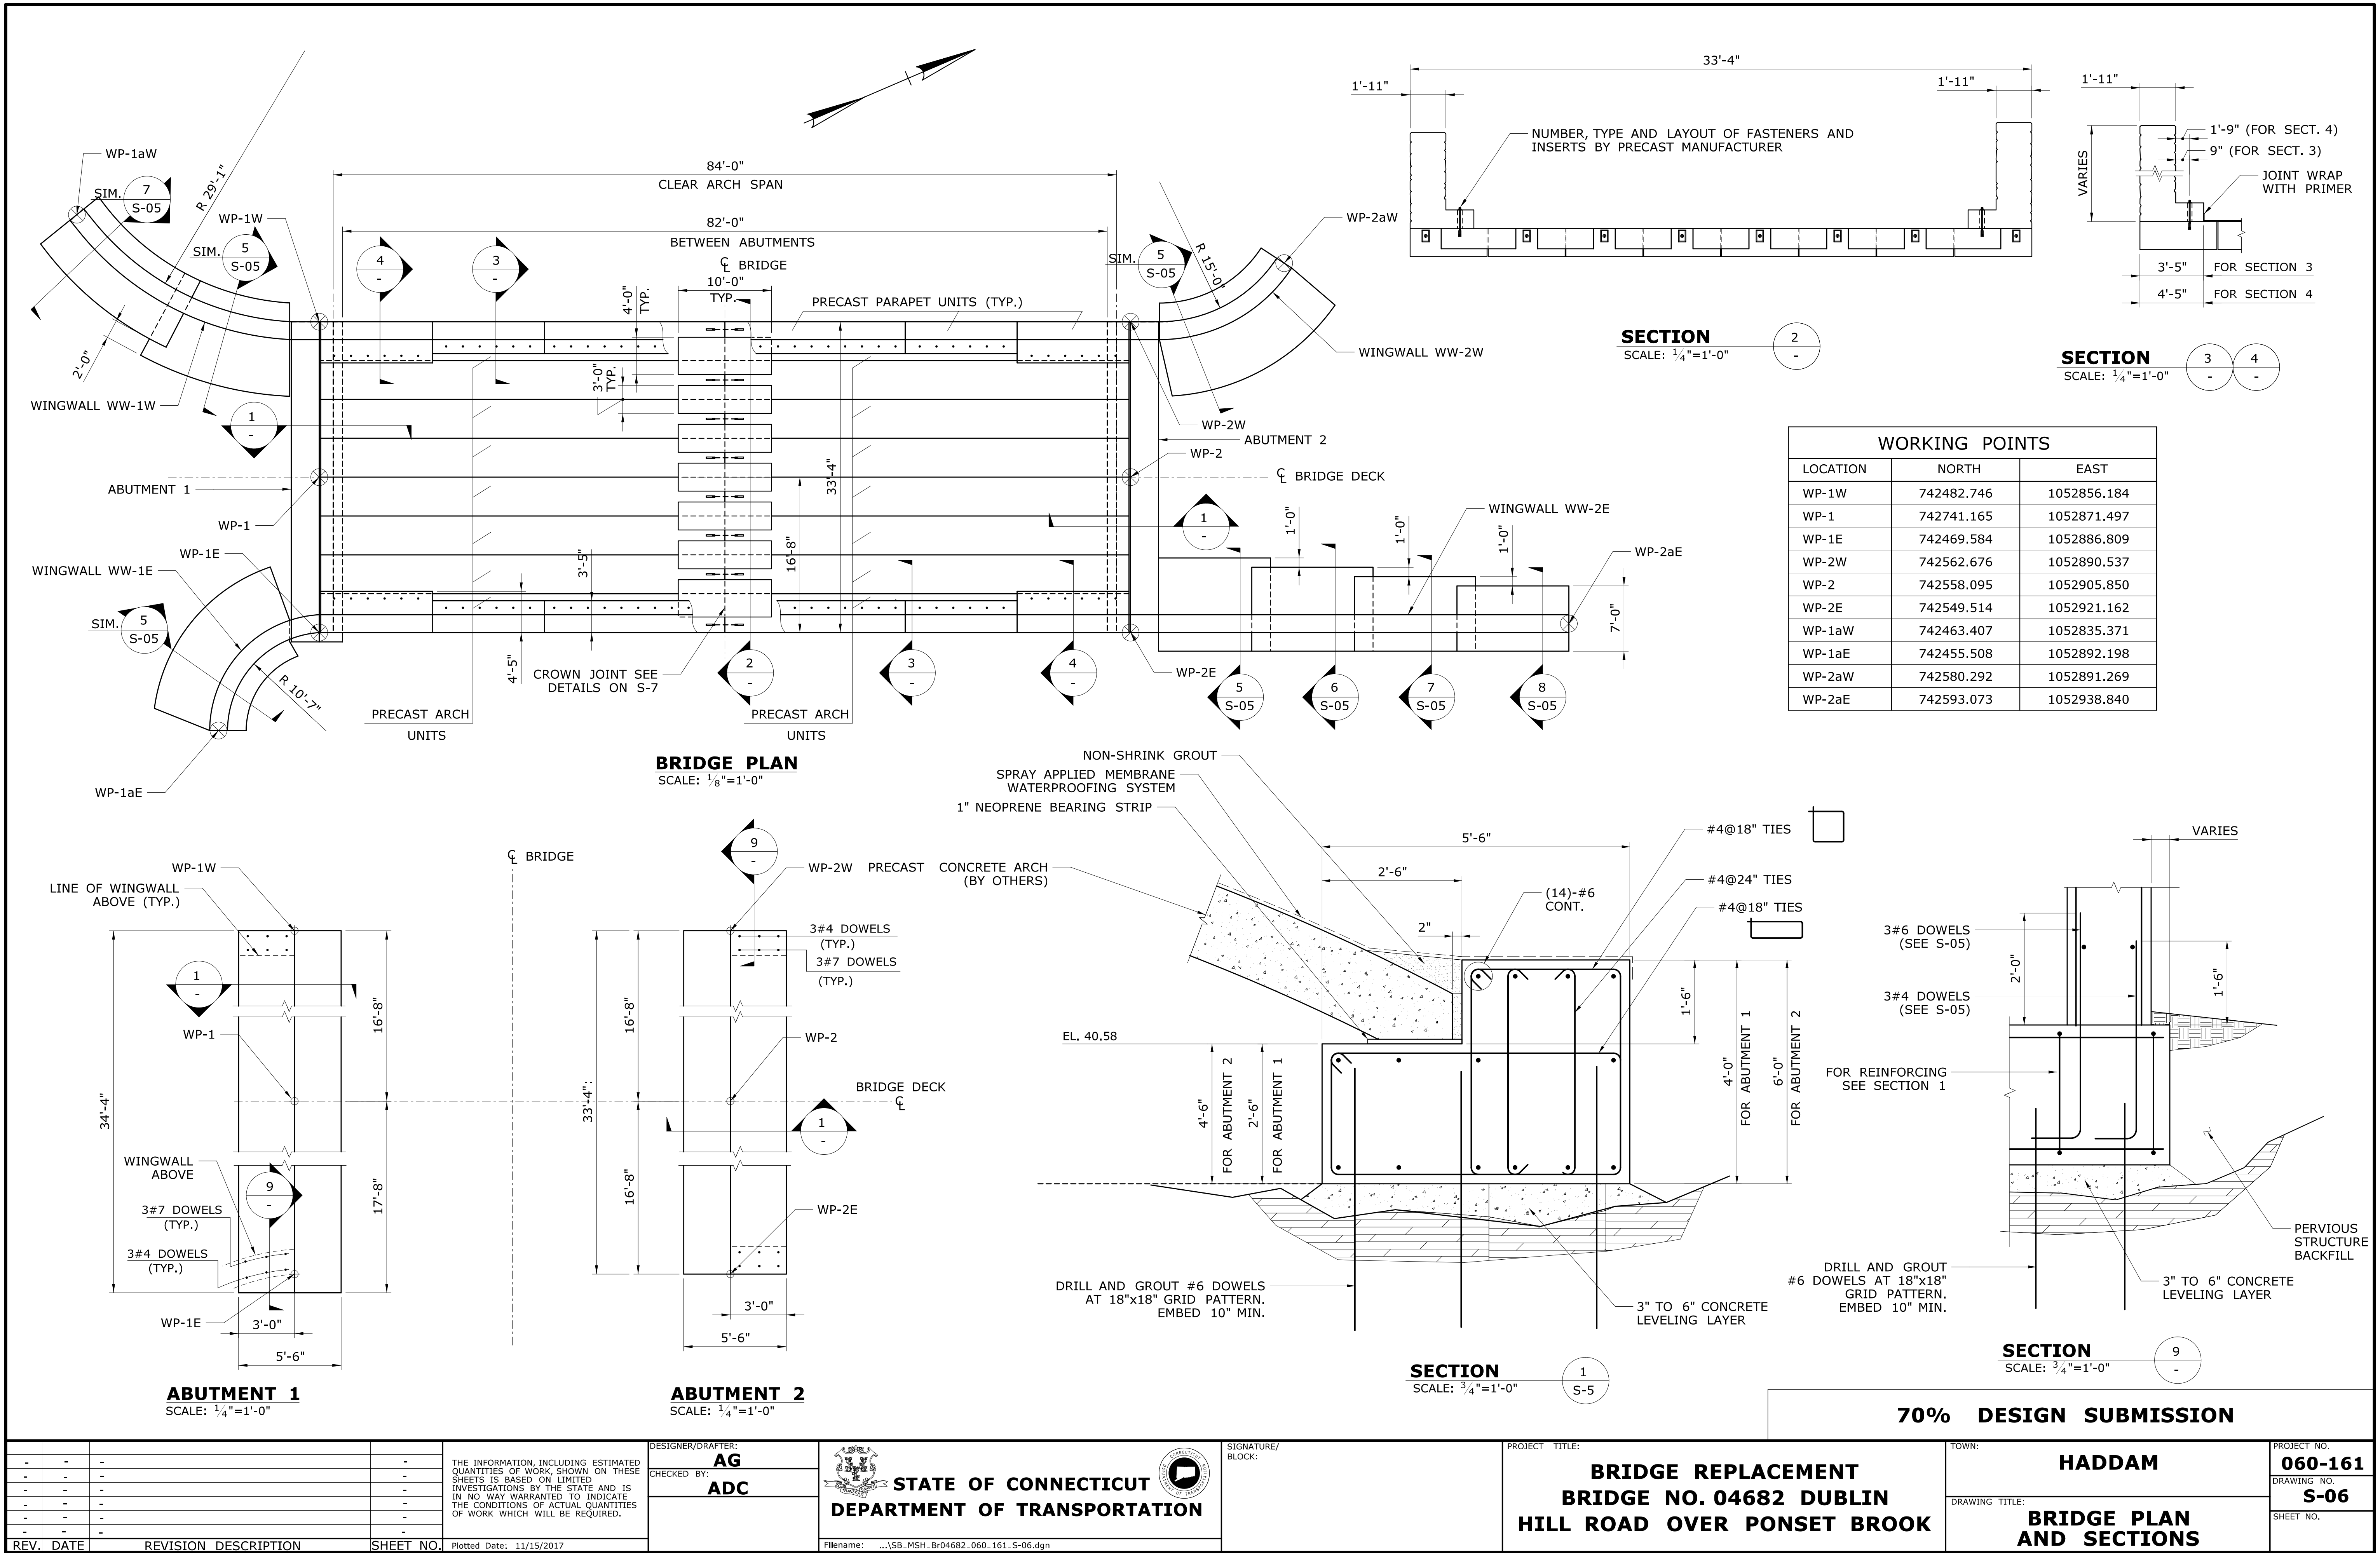

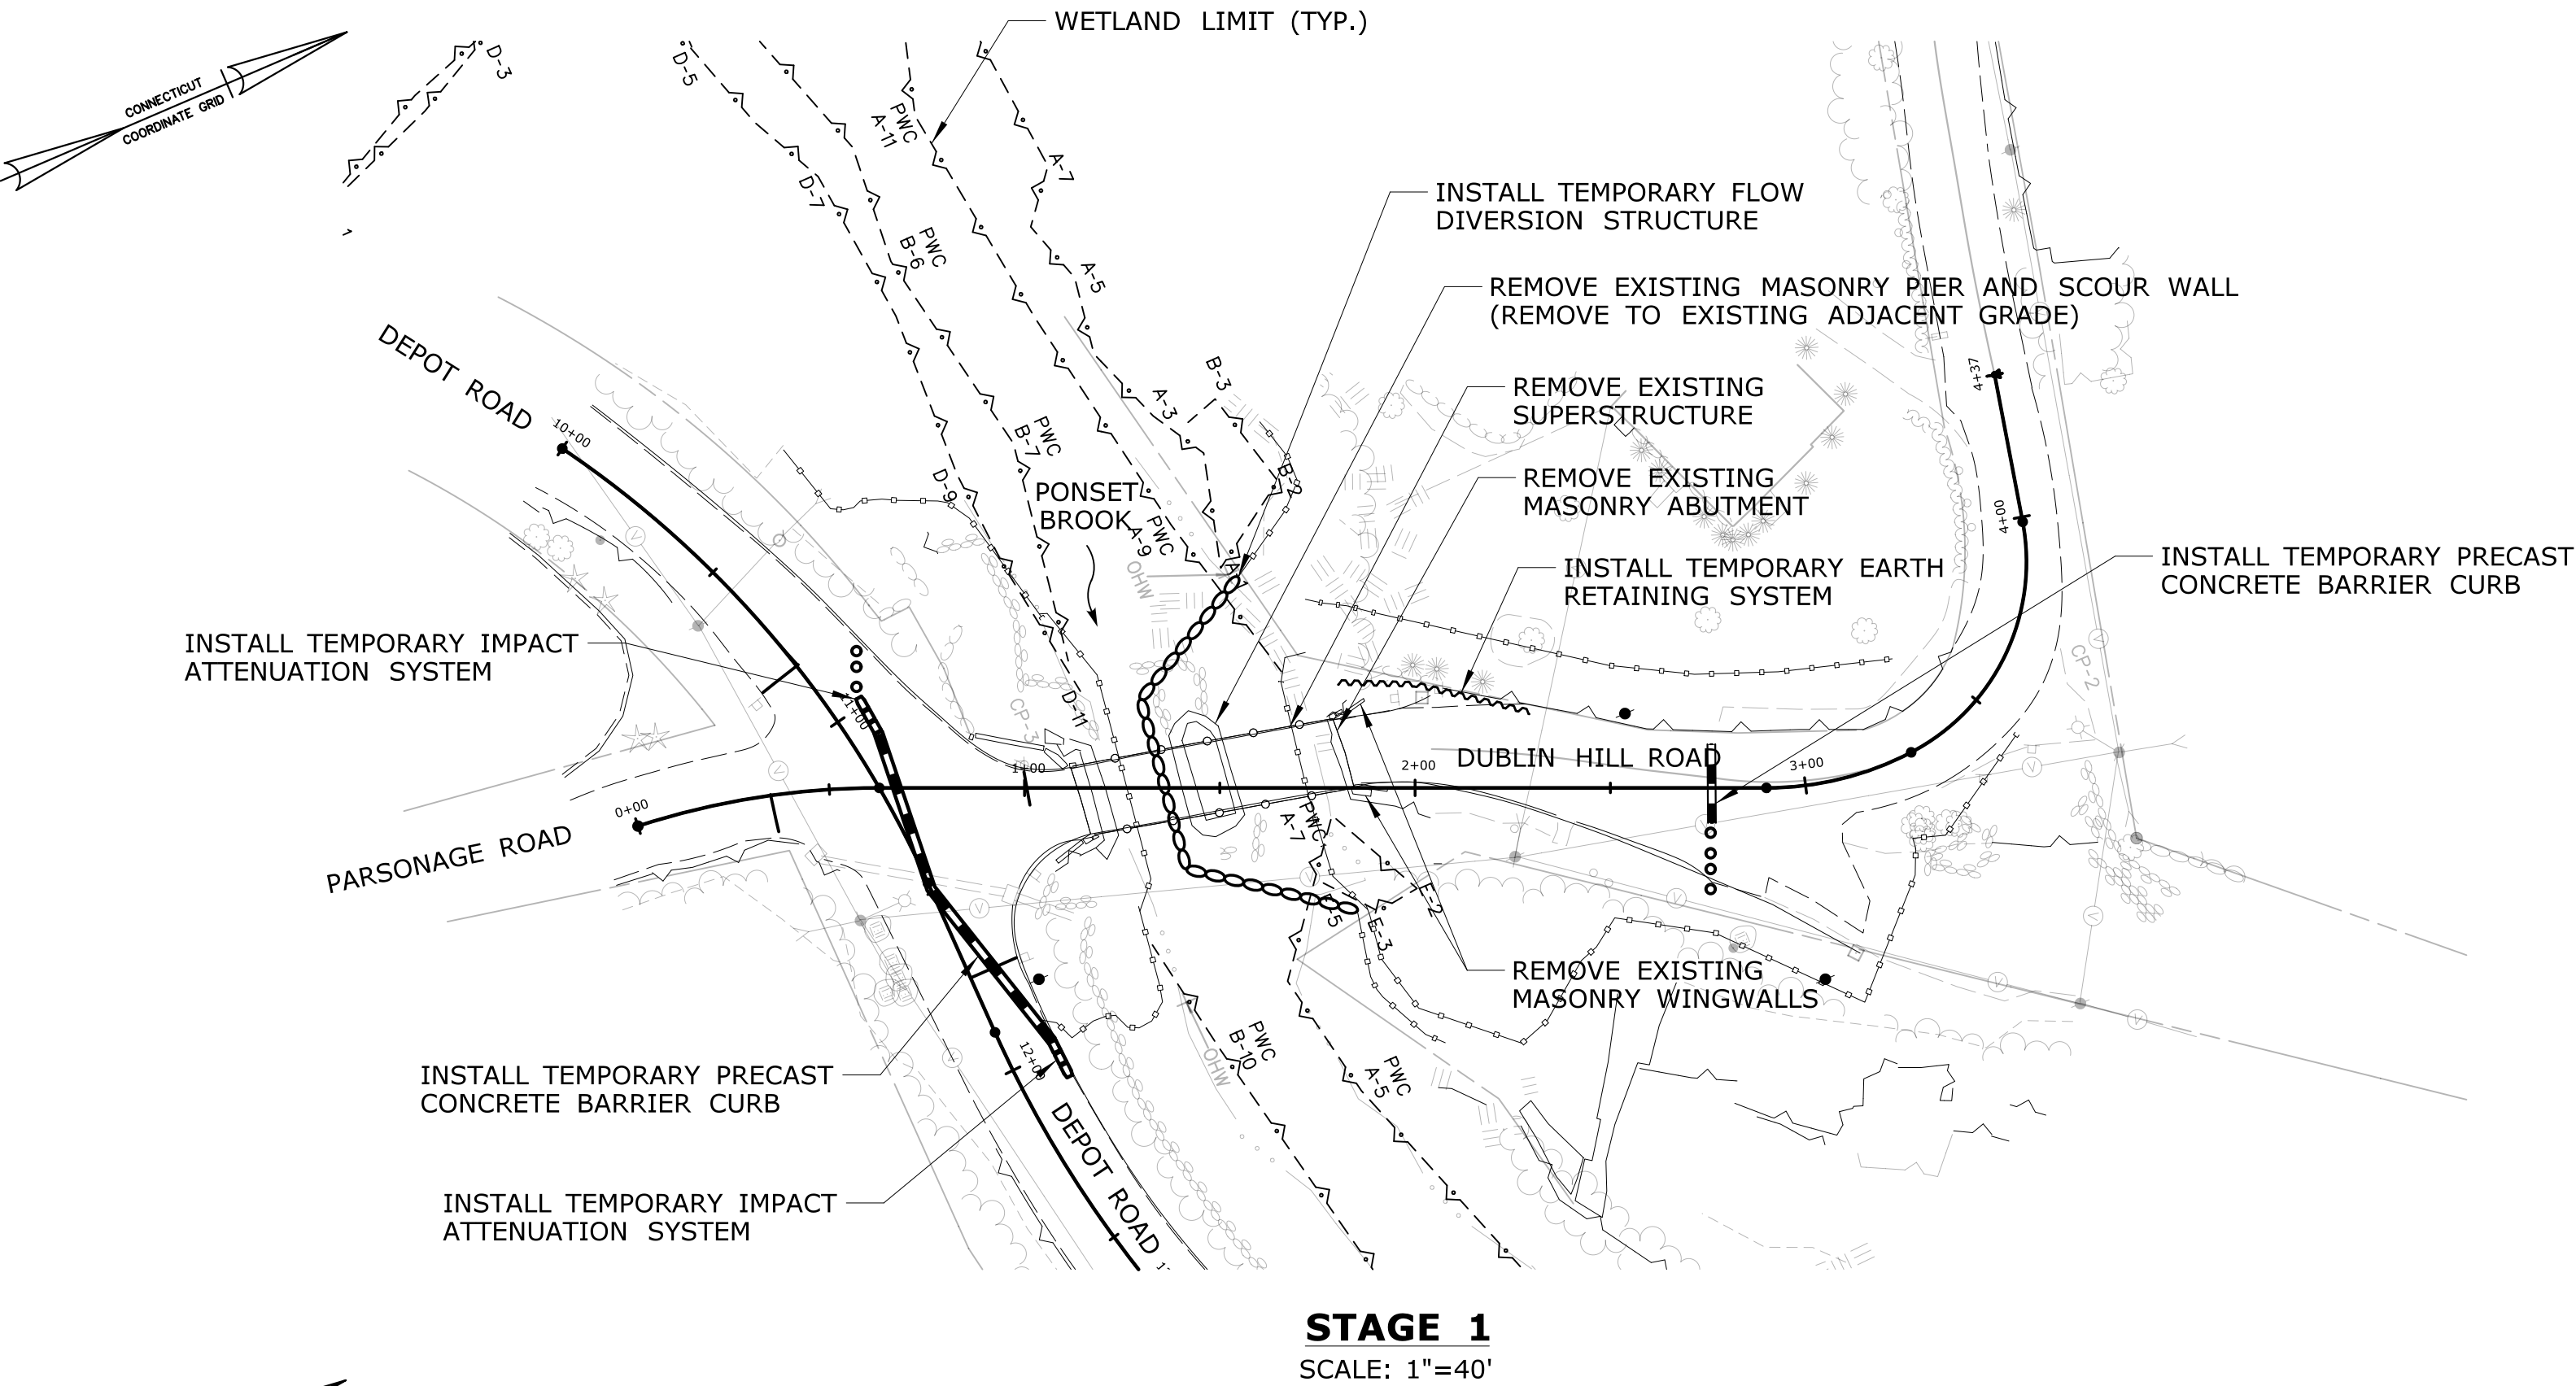

**STAGE 1**  
SCALE: 1"=40'

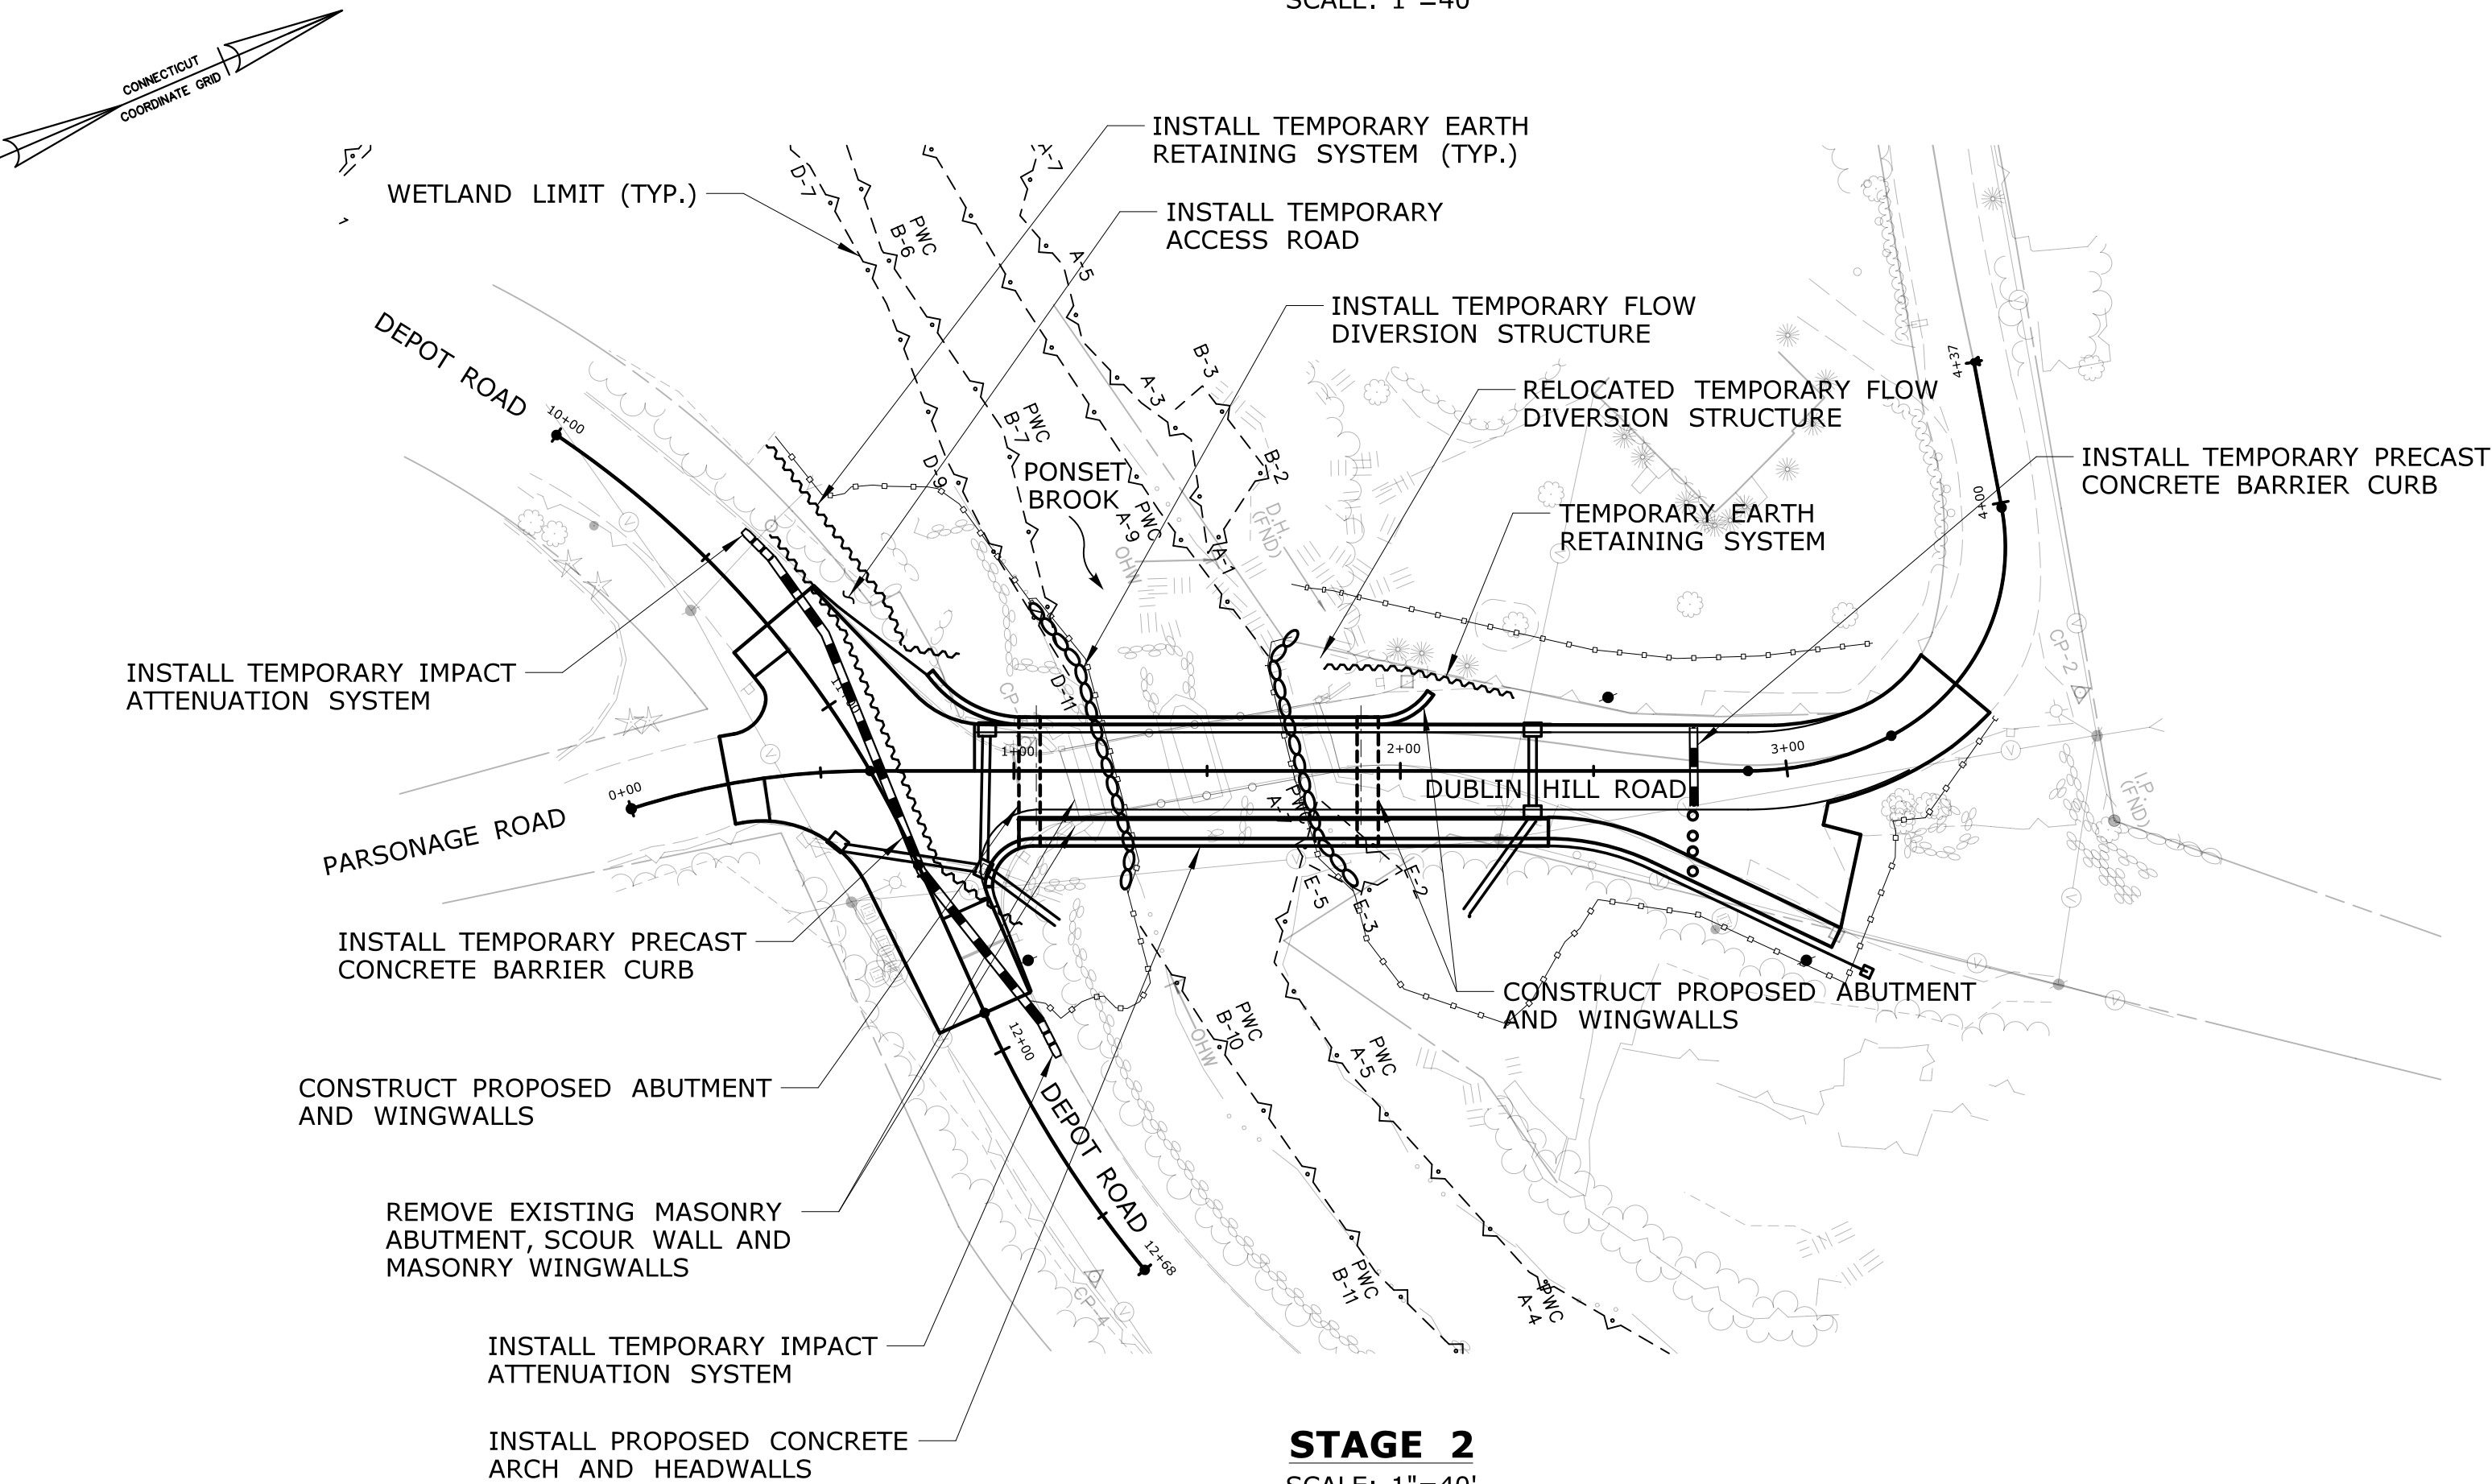

**STAGE 2**  
SCALE: 1"=40'

**SUGGESTED STAGE 1 CONSTRUCTION SEQUENCE**

1. IMPLEMENT DETOUR AND CLOSE THE BRIDGE.
2. INSTALL TEMPORARY PRECAST CONCRETE BARRIER CURB, TEMPORARY IMPACT ATTENUATION SYSTEM AND TEMPORARY PAVEMENT MARKINGS. IMPLEMENT ONE WAY ALTERNATING TRAFFIC PATTERN ON DEPOT ROAD.
3. INSTALL TEMPORARY FLOW DIVERSION STRUCTURE AS SHOWN IN THE STAGE 1 PLAN.
4. REMOVE EXISTING SUPERSTRUCTURE.
5. INSTALL TEMPORARY EARTH RETAINING SYSTEM AT NORTHWEST SIDE OF BRIDGE.
6. REMOVE EXISTING MASONRY ABUTMENT (NORTH), MASONRY WINGWALLS (NORTH) AND MASONRY PIER INCLUDING SCOUR WALL.
7. RELOCATE STAGE 1 TEMPORARY FLOW DIVERSION STRUCTURES AS SHOWN IN STAGE 2 BELOW.

**SUGGESTED STAGE 2 CONSTRUCTION SEQUENCE**

1. INSTALL TEMPORARY FLOW DIVERSION STRUCTURE ALONG THE SOUTH ABUTMENT AS SHOWN IN THE STAGE 2 PLAN.
2. INSTALL TEMPORARY PRECAST CONCRETE BARRIER CURB AND TEMPORARY IMPACT ATTENUATION SYSTEM ON DEPOT ROAD TO ACCOMMODATE STAGE 2 CONSTRUCTION.
3. INSTALL TEMPORARY EARTH RETAINING SYSTEM AT THE SOUTH SIDE OF THE BRIDGE.
4. CONSTRUCT TEMPORARY ACCESS ROAD.
5. REMOVE THE EXISTING MASONRY ABUTMENT (SOUTH) INCLUDING SCOUR WALL AND WINGWALLS (SOUTH).
6. CONSTRUCT PROPOSED ABUTMENT AND WINGWALL FOOTINGS (NORTH AND SOUTH).
7. INSTALL PROPOSED CONCRETE ARCH AND HEADWALLS.
8. CONSTRUCT WINGWALL STEMS.
9. BACKFILL AND INSTALL SIDEWALK AND PROPOSED DRAINAGE STRUCTURES.
10. REMOVE TEMPORARY EARTH RETAINING SYSTEM AND RECONSTRUCT THE ROADWAY APPROACHES.
11. ESTABLISH FINISHED GRADES AT WINGWALLS AND ABUTMENTS.
12. OPEN THE BRIDGE TO TRAFFIC AND PERFORM GENERAL SITE CLEAN UP.


**NOTE:**

1. CONTRACTOR SHALL MAINTAIN DRAINAGE ALONG DUBLIN HILL ROAD AND DEPOT ROAD DURING CONSTRUCTION OPERATIONS. CONTRACTOR IS RESPONSIBLE FOR HANDLING THE FLOW FROM THE EXISTING CATCH BASIN BY GRADING TO DRAIN, PIPING, OR OTHER MEANS AS DESIGNED BY THE CONTRACTOR. MEANS FOR HANDLING THESE FLOWS SHALL BE INCLUDED IN THE "HANDLING WATER" SUBMISSION. ALL COST ASSOCIATED WITH HANDLING THESE FLOWS SHALL BE INCLUDED IN THE COST OF THE ITEM "HANDLING WATER".
2. TEMPORARY FLOW DIVERSION STRUCTURE SHALL BE PAID FOR UNDER THE ITEM FOR WATER HANDLING.

HYDRAULIC DATA	
AVERAGE DAILY FLOW (CFS)	XXX
AVERAGE SPRING FLOW (CFS)	XXX
2-YR FREQUENCY DISCHARGE (CFS)	XXX
TEMPORARY DESIGN DISCHARGE (CFS)	XXX
TEMPORARY DESIGN FREQUENCY	XXX
TEMPORARY UPSTREAM WATER SURFACE EL. (FT)	XXX
TEMPORARY DOWNSTREAM WATER SURFACE EL. (FT)	XXX

**70% DESIGN SUBMISSION**

REV.	DATE	REVISION DESCRIPTION	SHEET NO.	Plotted Date: 11/15/2017	DESIGNER/DRAFTER: <b>AG</b> CHECKED BY: <b>ADC</b> SCALE IN FEET 0 40 80 SCALE 1"=40'	 <b>STATE OF CONNECTICUT</b> <b>DEPARTMENT OF TRANSPORTATION</b> Filename: ...\\SB_MSH_Br04682_060_161_S-07.dgn	SIGNATURE/ BLOCK:	PROJECT TITLE: <b>BRIDGE REPLACEMENT BRIDGE NO. 04682 DUBLIN HILL ROAD OVER PONSET BROOK</b>	TOWN: <b>HADDAM</b> DRAWING TITLE: <b>STAGING PLAN</b>	PROJECT NO. <b>060-161</b> DRAWING NO. <b>S-07</b> SHEET NO.
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70% DESIGN SUBMISSION

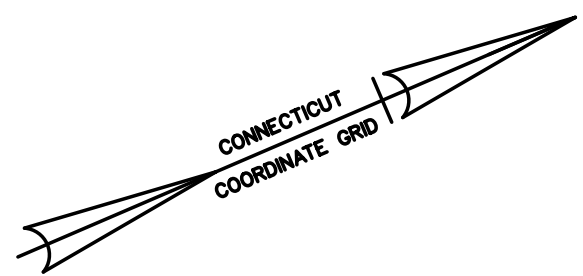REV.	DATE	REVISION DESCRIPTION	SHEET NO.

THE INFORMATION, INCLUDING ESTIMATED QUANTITIES OF WORK, SHOWN ON THESE SHEETS IS BASED ON LIMITED INVESTIGATIONS BY THE STATE AND IS IN NO WAY WARRANTED TO INDICATE THE CONDITIONS OF ACTUAL QUANTITIES OF WORK WHICH WILL BE REQUIRED.

Plotted Date: 11/15/2017


DESIGNER/DRAFTER:  
**AG**

CHECKED BY:  
**ADC**

SCALE IN FEET

0 10 20

SCALE 1"=10'

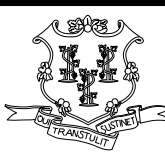 **STATE OF CONNECTICUT**  
**DEPARTMENT OF TRANSPORTATION**

Filename: ...\\SB\_MSH\_Br04682\_060\_161\_S-08.dgn

SIGNATURE/  
BLOCK:

PROJECT TITLE:

**BRIDGE REPLACEMENT  
BRIDGE NO. 04682 DUBLIN  
HILL ROAD OVER PONSET BROOK**

TOWN: **HADDAM**

DRAWING TITLE:  
**SOIL BORING  
LOCATION PLAN**

PROJECT NO.  
**060-161**


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**S-08**

SHEET NO.









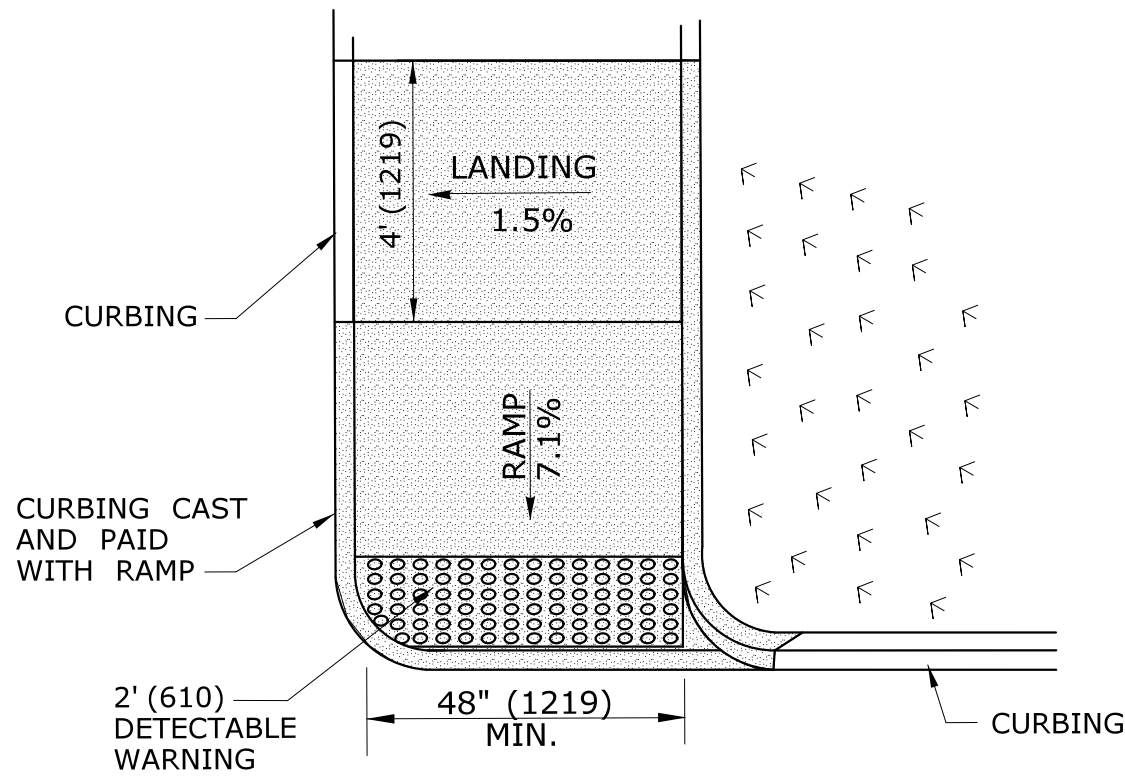

**SINGLE DIRECTION  
PERPENDICULAR SIDEWALK RAMP  
NO / UTILITY GRASS STRIP  
(TYPE 4a)**

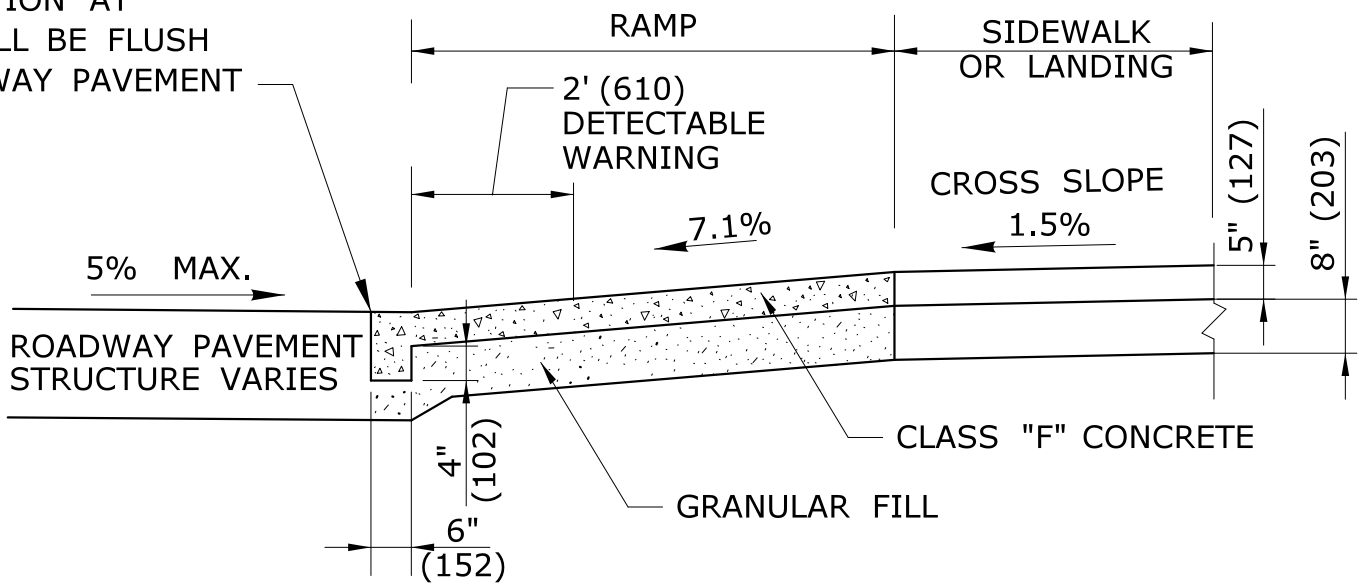


**TYPICAL SECTION THRU SIDEWALK RAMP**  
SEE NOTE 2 AND 17

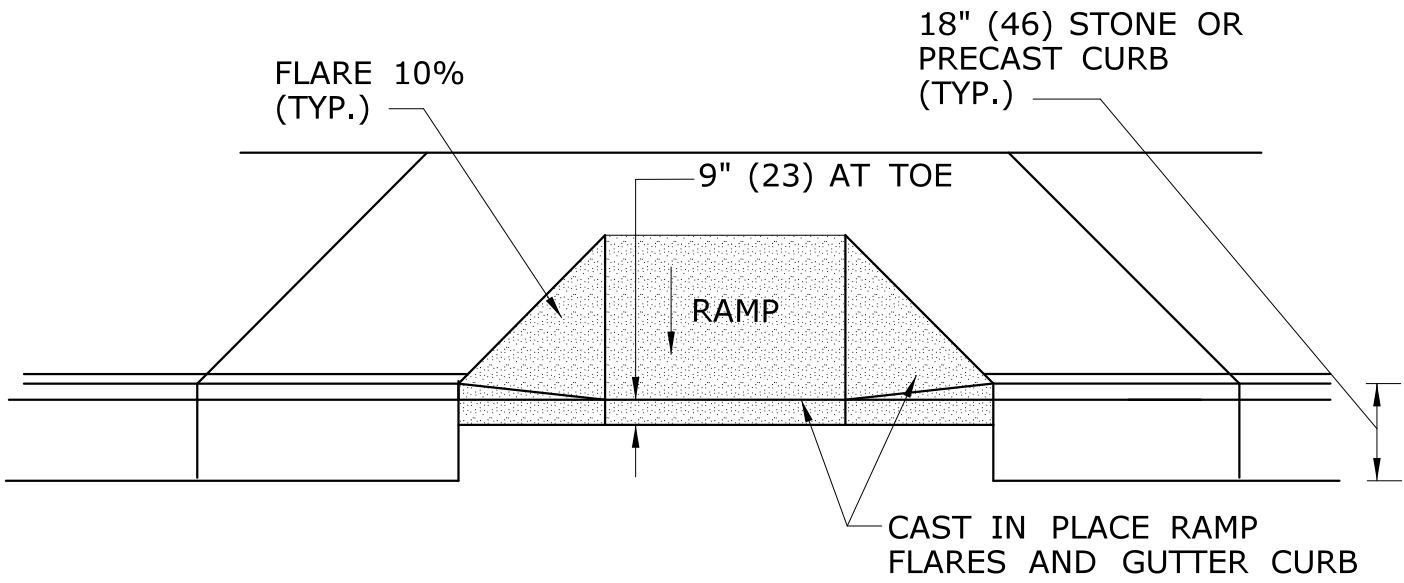

**TYPICAL ELEVATION PERPENDICULAR SIDEWALK RAMP  
WITH CAST IN PLACE GUTTER**

ALL METRIC DIMENSIONS ARE IN MILLIMETERS (mm) UNLESS OTHERWISE NOTED

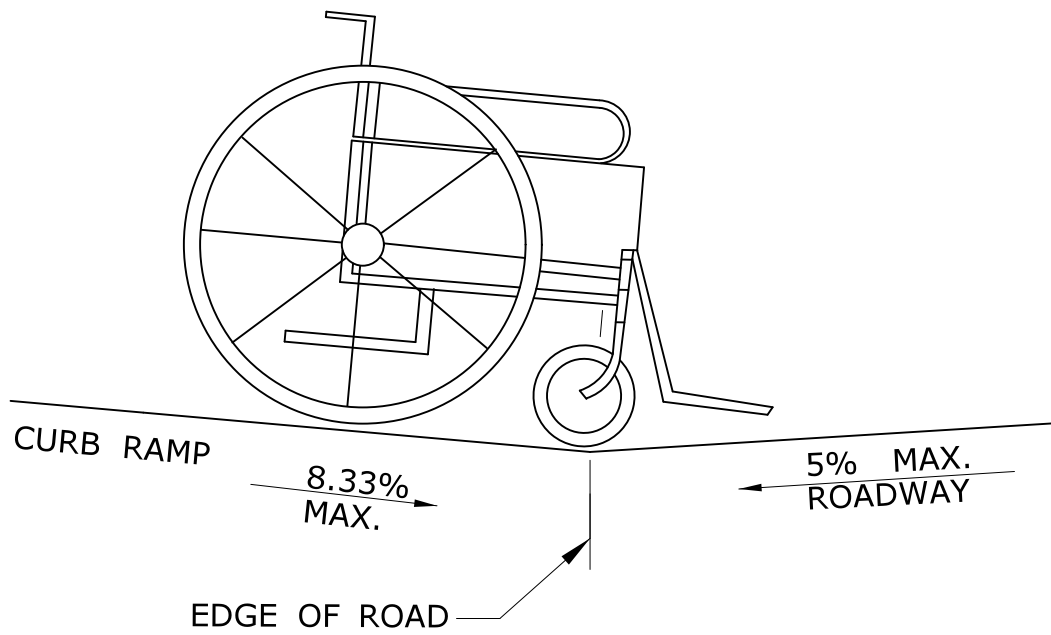


**DETAIL 1**  
**SEE GRADE CHANGE AT ROADWAY INTERFACE**  
SEE NOTE 1

### GENERAL NOTES:

1. MAXIMUM SLOPES OF ADJOINING GUTTERS AND ROAD SURFACES IMMEDIATELY ADJACENT TO THE SIDEWALK RAMP SHOULD NOT EXCEED 5%. THE MAXIMUM GRADE DIFFERENCE BETWEEN THE GUTTER AND CURB RAMP SHALL NOT EXCEED 13%. SEE DETAIL 1 ON SHEET 4.
2. RAMP GRADE SHALL BE UNIFORM, FREE OF SAGS AND ABRUPT GRADE CHANGES. RUNNING SLOPES OF RAMPS SHALL NOT EXCEED 8.33% AND SHALL NOT EXCEED 15' (4.5m) WITHOUT PROVIDING A LANDING.
3. ALL RAMPS SHALL BE CONSTRUCTED OF CLASS "F" CONCRETE IN ACCORDANCE WITH CONNECTICUT STANDARD SPECIFICATIONS.
4. SIDEWALK RAMPS SHALL HAVE A COARSE BROOM FINISH TRANSVERSE TO THE SLOPE OF THE RAMP. THE SURFACE OF ALL SIDEWALK RAMPS SHALL BE STABLE, FIRM AND SLIP RESISTANT. SURFACE DISCONTINUITIES SHALL NOT EXCEED 1/2" (13) MAX. VERTICAL DISCONTINUITIES BETWEEN 1/4" (6.4) AND 1/2" (13) MAX. SHALL BE BEVELED 1:2 MINIMUM APPLIED ACROSS THE ENTIRE LEVEL CHANGE.
5. DIAGONAL SIDEWALK RAMPS AT MARKED CROSSINGS SHALL BE WHOLLY CONTAINED WITHIN THE MARKINGS, EXCLUDING ANY FLARED SIDES. DIAGONAL AND PERPENDICULAR RAMPS SHALL HAVE THE RAMP CUT PERPENDICULAR TO THE TANGENT OF THE CURB RADIUS FOR THE DESIGNATED ACCESSIBLE ROUTE. BOTH LONGITUDINAL SIDES OF THE RAMP SHOULD BE THE SAME LENGTH. SKEWED RAMPS SHOULD BE AVOIDED. FLARES ARE NOT CONSIDERED PART OF PEDESTRIAN ACCESS ROUTE. DIAGONAL RAMPS SHOULD NOT BE INSTALLED WHERE CURB RADII IS LESS THAN 20'(6096).
6. REMOVAL OF EXISTING SIDEWALK FOR NEW RAMP INSTALLATIONS SHALL BE TO THE NEAREST EXPANSION OR CONTRACTION JOINT. 8.3% MAXIMUM SLOPE MAY NOT BE ACHIEVABLE DUE TO EXISTING SIDEWALK GRADE. IN RECOGNITION OF THIS, A LIMIT OF 15' (4572) FOR REMOVAL SHALL BE USED UNLESS OTHERWISE SHOWN ON THE PLANS OR DIRECTED BY THE ENGINEER. SAW CUT REQUIRED FOR DUMMY JOINTS SHALL BE INCLUDED IN THE COST OF "CONCRETE SIDEWALK RAMP" OR "CONCRETE SIDEWALK".
7. EXPANSION JOINTS IN CONCRETE SHALL MATCH THOSE IN ADJACENT SIDEWALKS BUT IN NO CASE SHALL THE SPACING BETWEEN EXPANSION JOINTS EXCEED 12' (3658) UNLESS OTHERWISE NOTED.
8. CONCRETE SIDEWALK RAMPS, SHALL BE PAID FOR UNDER THE ITEM "CONCRETE SIDEWALK RAMP", AS DEFINED BY THE CONSTRUCTION LIMITS ON THE PLANS AND SHALL BE FIELD VERIFIED.
9. SIDEWALK RAMPS SHALL BE CONSTRUCTED WITH THE TOE AT THE GUTTER CAST INTEGRALLY WITH RAMP UNLESS DIRECTED OTHERWISE BY THE ENGINEER (SEE TYPICAL SECTION ON SHEET 3). CURB REMOVAL AND CAST IN PLACE CURBING REQUIRED FOR THE RAMP, SHALL BE INCLUDED WITH PAY ITEM "CONCRETE SIDEWALK RAMP". CURBING OUTSIDE LIMITS OF RAMP OR LANDING SHOWN ON SHEET 3 SHALL BE CONSTRUCTED AND PAID FOR IN ACCORDANCE WITH CONNECTICUT STANDARD SPECIFICATIONS.
10. PREFERRED LOCATION TO INSTALL DETECTABLE WARNING STRIP SHALL BE 6" (152) FROM THE EDGE OF ROAD ALONG THE FULL WIDTH OF THE RAMP. FOR ALTERNATE LOCATIONS, REFER TO DETECTABLE WARNING PLACEMENT DETAILS ON SHEET 4.
11. TO PERMIT WHEELCHAIR WHEELS TO ROLL BETWEEN DOMES, ALIGN DOMES ON A SQUARE GRID IN THE DIRECTION OF RUNNING SLOPE (PERPENDICULAR TO CURB OR SLOPE BREAK). THE TRANSITION FROM RAMP TO GUTTER SHALL BE FLUSH WITHOUT A LIP.
12. WHERE COMMERCIAL DRIVEWAYS ARE PROVIDED WITH TRAFFIC SIGNALS AND THE SIDEWALK IS CONTINUOUS THROUGH DRIVEWAY, DETECTABLE WARNINGS ARE REQUIRED AT THE JUNCTION BETWEEN THE PEDESTRIAN ROUTE AND DRIVEWAY.
13. CONSTRUCT A SIDEWALK CURB WHEN THERE IS INSUFFICIENT BUFFER AVAILABLE TO GRADE OR WHEN CALLED FOR IN PLANS. PAID FOR WITH SIDEWALK RAMP WHEN REQUIRED FOR RAMP.
14. THE TOP AND BOTTOM OF RAMPS SHOULD BE PROVIDED WITH A 4' x 4' (1219 x 1219) MINIMUM LEVEL LANDING AREA WITH A CROSS SLOPE LESS THAN OR EQUAL TO 2% IN ANY DIRECTION.
15. UTILITY POLES, LUMINAIRE, PEDESTRIAN OR SIGNAL POLES, GRATES, ACCESS COVERS, AND OTHER APPURTENANCES SHALL NOT BE LOCATED ON RAMPS, LANDINGS, BLENDED TRANSITIONS, AND @ GUTTERS WITHIN THE PEDESTRIAN ACCESS ROUTE.
16. APPROACH SIDEWALK WIDTHS, GRASS STRIP OR UTILITY STRIP WIDTHS MAY VARY.
17. APPROACH SIDEWALK AND LANDING CROSS SLOPE SHALL NOT EXCEED 2%.
18. THE RUNNING OR CROSS SLOPES ON LANDINGS AT MID BLOCK CROSSING MAY BE WARPED TO MEET STREET OR HIGHWAY GRADE.
19. FOR PERPENDICULAR CURB RAMPS A MIN. 4'(1.2m) x 4'(1.2m) LEVEL LANDING SHALL BE PROVIDED AT THE TOP OF CURB RAMP. WHERE THE LEVEL LANDING IS RESTRICTED AT THE BACK OF SIDEWALK THE LEVEL LANDING SHALL BE 4'(1.2m) x 5'(1.5m) WITH THE 5'(1.5m) DIMENSION PROVIDED IN THE DIRECTION OF THE RAMP RUN.
20. FOR PARALLEL CURB RAMPS, A MIN. 4'(1.2m) x 4'(1.2m) LEVEL LANDING SHALL BE PROVIDED AT THE BOTTOM OF CURB RAMP. IF THE LEVEL LANDING IS RESTRICTED ON 2 OR MORE SIDES, THE LEVEL LANDING SHALL BE 4'(1.2m)x 5'(1.5m) WITH THE 5' (1.5m) DIMENSION PROVIDED IN THE DIRECTION OF THE PEDESTRIAN STREET CROSSING.
21. WHEN WIDTH OF SIDEWALK IS ≥48" AND A PERPENDICULAR SIDEWALK RAMP IS INSTALLED, THE FLARED SIDES SHALL BE 10% MAX. IF WIDTH OF SIDEWALK IS <48" THE FLARED SIDES MUST NOT EXCEED 8.33% (12:1).
22. SHADED AREAS ARE TYPICAL PAY LIMITS FOR CONCRETE SIDEWALK RAMP BUT, MAY VARY AS DIRECTED BY THE ENGINEER.
23. OPTIONAL RAMP, WHEN REQUIRED, SHALL BE PAID FOR AS PART OF CONCRETE SIDEWALK RAMP.


### NOTES:


1. RAMPED MEDIANS SHALL HAVE A CURB RAMP AT EITHER END AND LEVEL LANDING A MINIMUM OF 5' x 5' (1.5m x 1.5m) IN BETWEEN. CUT-THROUGH MEDIANS SHALL BE A MINIMUM OF 6' (1.8m) LONG AND 5' (1.5m) WIDE. FOR ALL MEDIANS, CUT-THROUGH OR RAMPED, A 2' (610) STRIP OF DETECTABLE WARNINGS SHALL BE INSTALLED AT THE ENTRANCE AND EXIT.
2. SEE GENERAL NOTES.

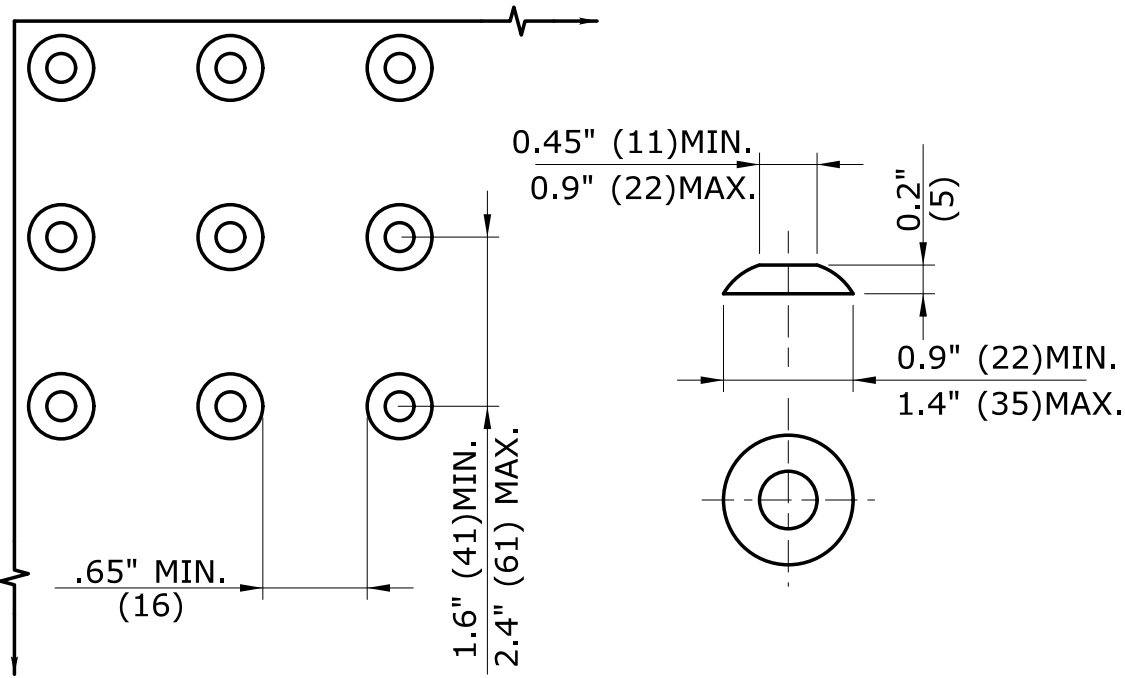


**DOMES SPACING      DOME SECTION**  
**STANDARD DOME ON DETECTABLE WARNING TILES**

**70% DESIGN SUBMISSION**


REV.	DATE	REVISION DESCRIPTION	SHEET NO.	Plotted Date: 11/15/2017	DESIGNER/DRAFTER: <b>JK</b> CHECKED BY: <b>ADC</b> SCALE AS NOTED	 <b>STATE OF CONNECTICUT DEPARTMENT OF TRANSPORTATION</b> Filename: ...\\SB_MSH_Br04682_060_161_S-10.dgn	SIGNATURE/ BLOCK:	PROJECT TITLE: <b>BRIDGE REPLACEMENT BRIDGE NO. 04682 DUBLIN HILL ROAD OVER PONSET BROOK</b>	TOWN: <b>HADDAM</b> DRAWING TITLE: <b>SIDEWALK RAMP DETAILS</b>	PROJECT NO. <b>060-161</b> DRAWING NO. <b>S-10</b> SHEET NO.
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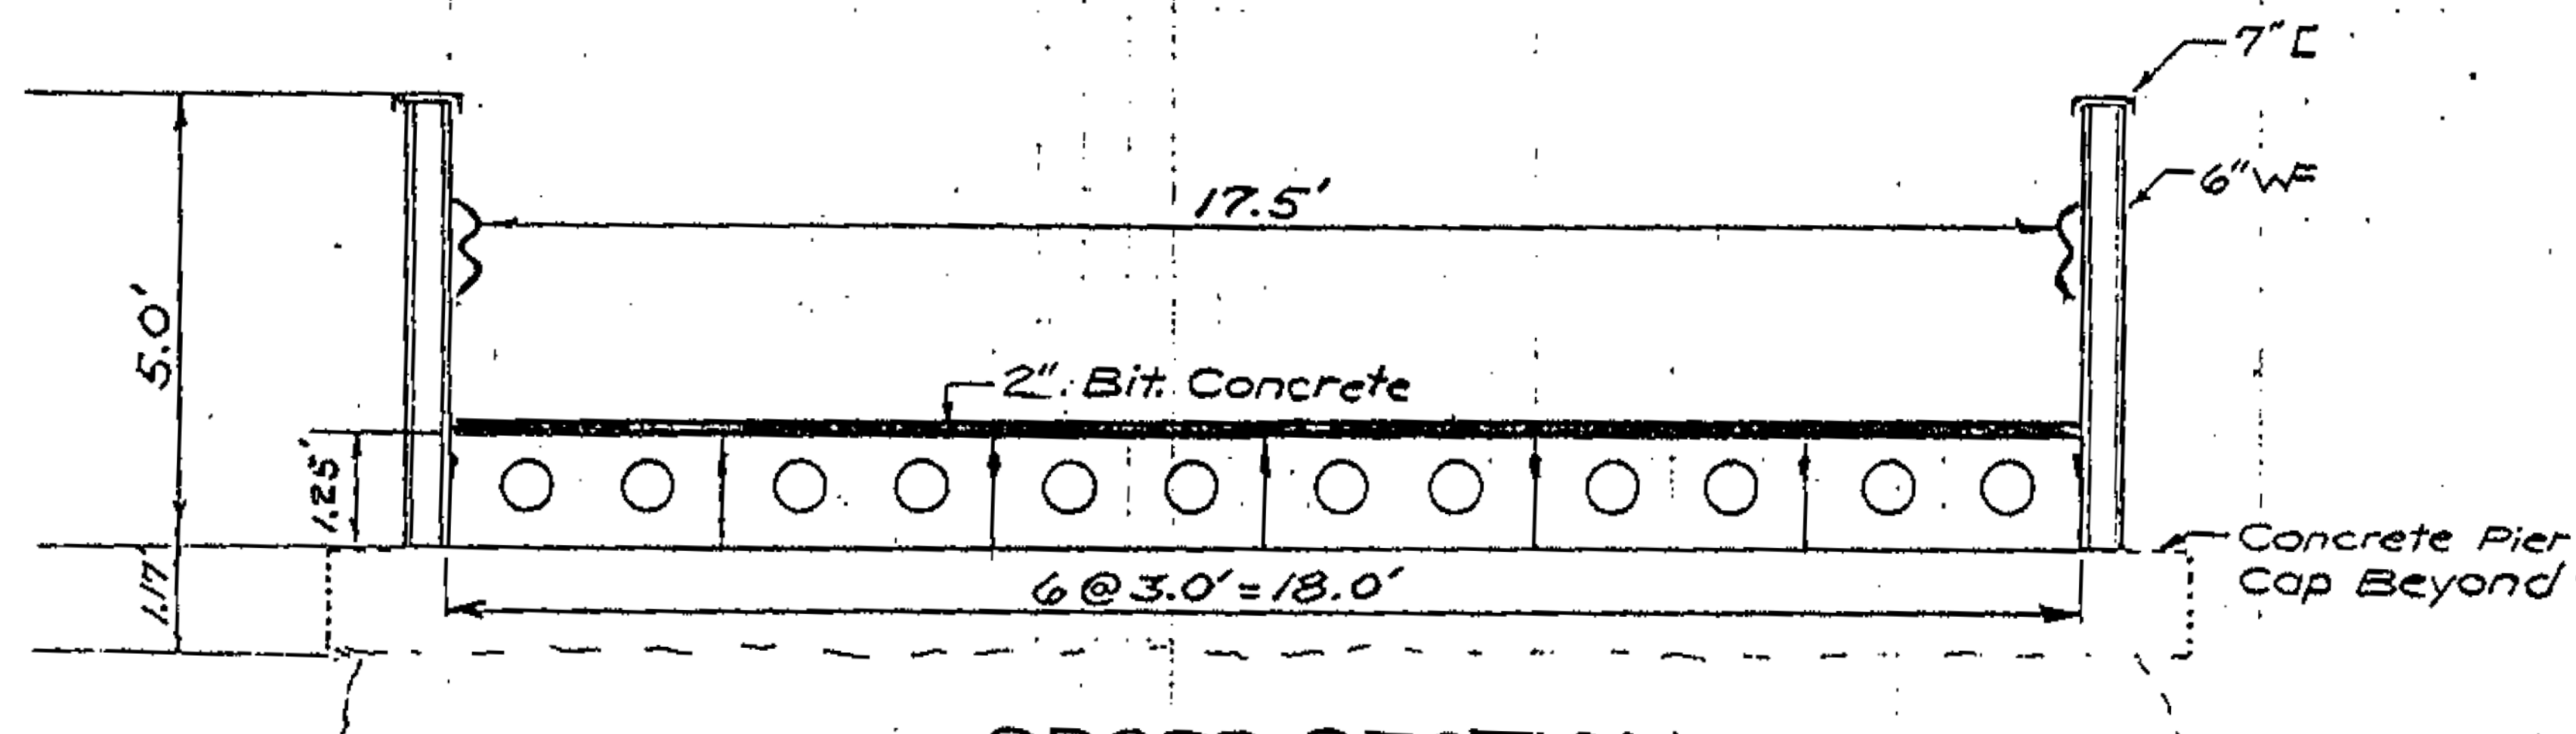
**ELEVATION**  
FACING DOWN STREAM

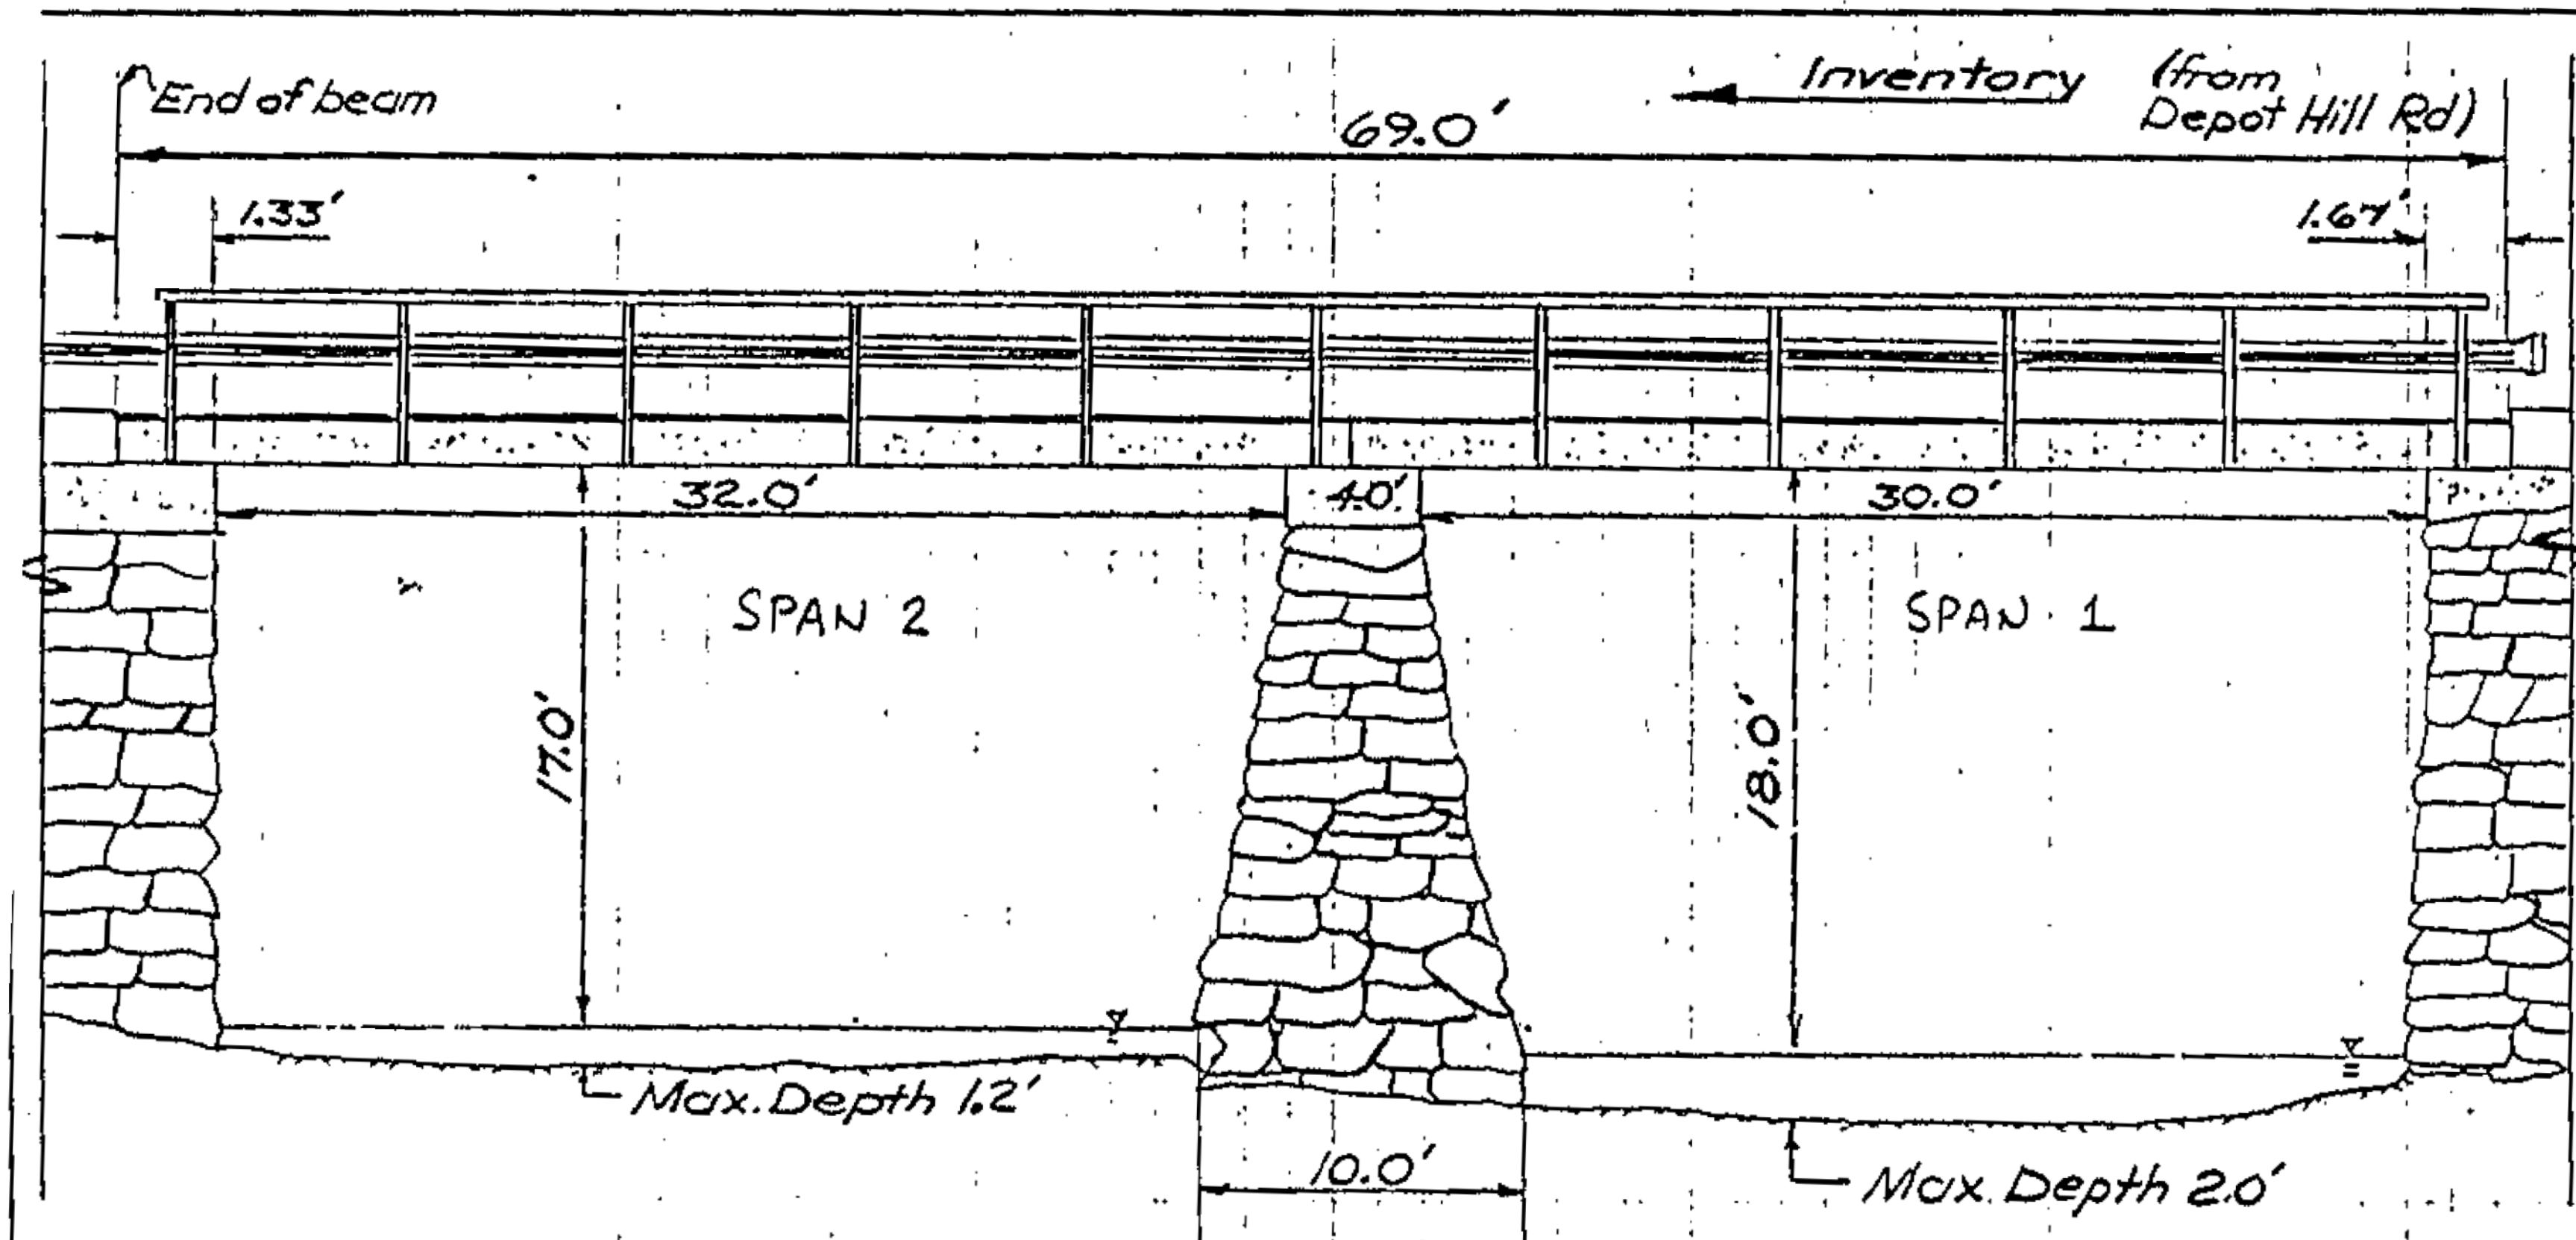

**LOCATION PLAN**

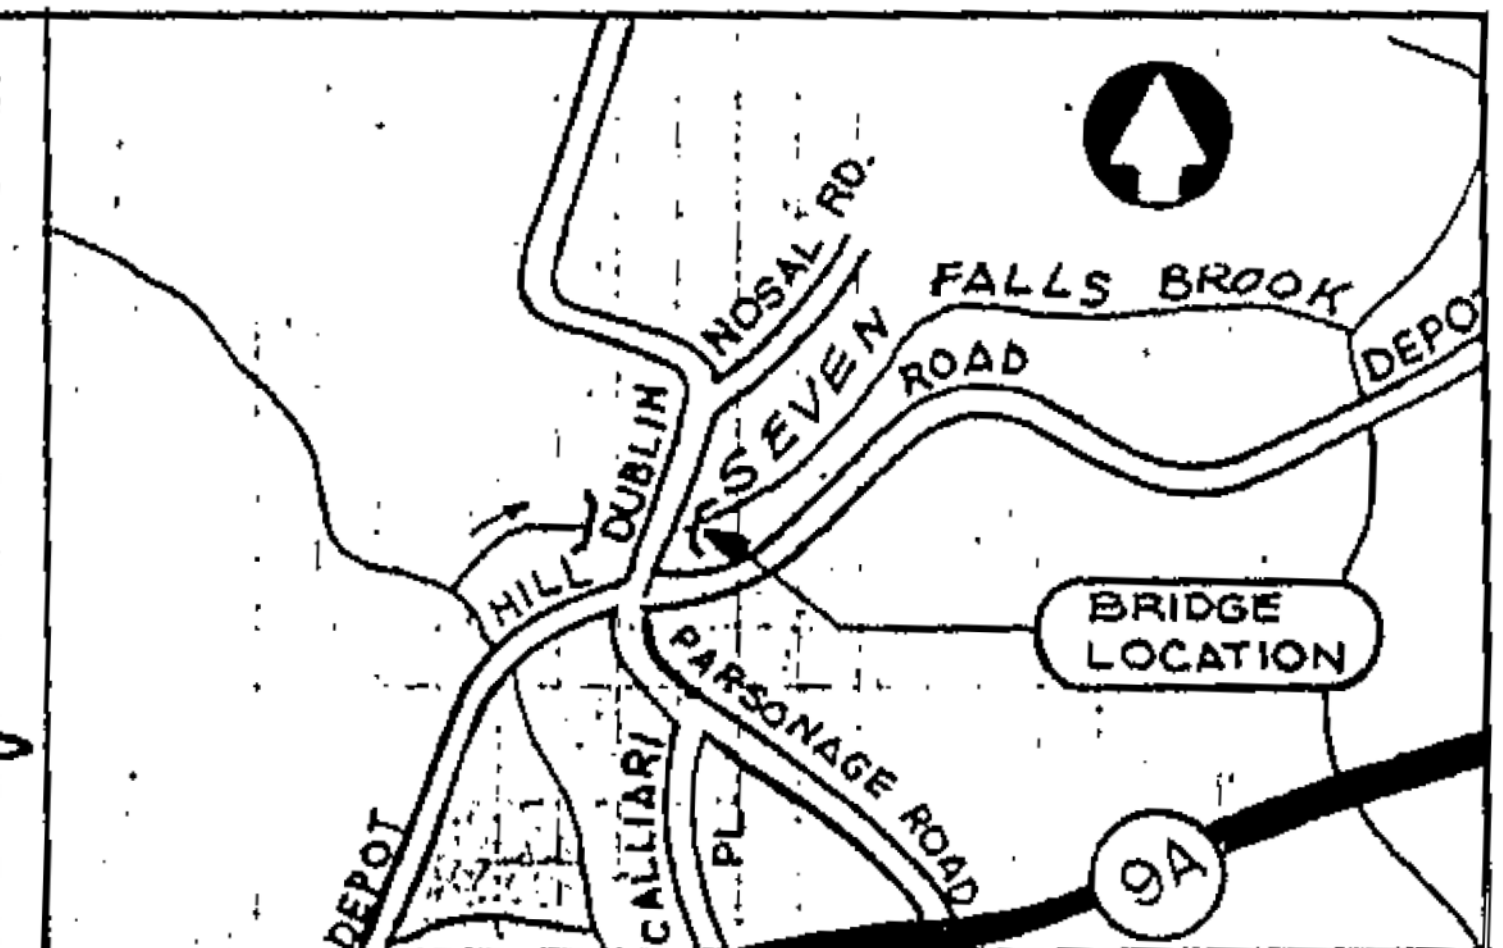

**PLAN**

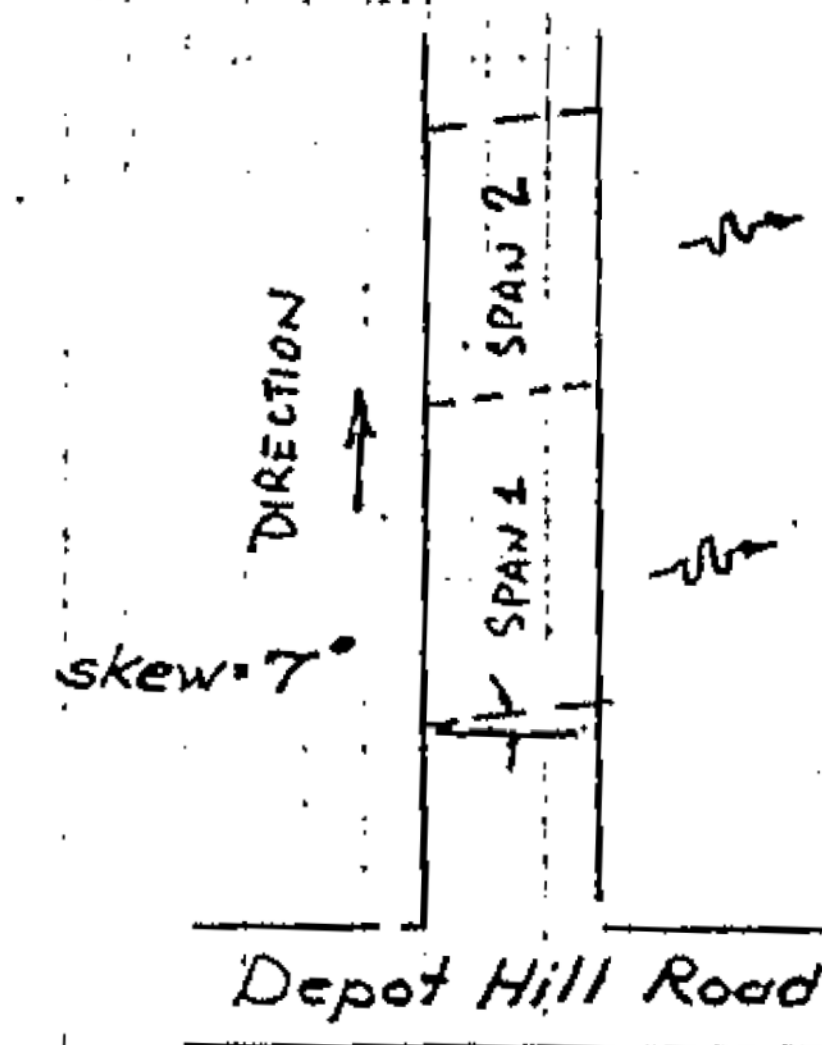

**CROSS SECTION**

CONN. DEPT. OF TRANSPORTATION

HADDAM  
DUBLIN HILL ROAD  
OVER  
SEVEN FALLS BROOK


PLANS PREPARED BY  
MACCHI ENGINEERS, HARTFORD CT.

DATE 5-16-80 SHT. 1 OF 2

CDOT BR. NO. 04682

FOR REFERENCE ONLY

70% DESIGN SUBMISSION

					THE INFORMATION, INCLUDING ESTIMATED QUANTITIES OF WORK, SHOWN ON THESE SHEETS IS BASED ON LIMITED INVESTIGATIONS BY THE STATE AND IS IN NO WAY WARRANTED TO INDICATE THE CONDITIONS OF ACTUAL QUANTITIES OF WORK WHICH WILL BE REQUIRED.	DESIGNER/DRAFTER: <b>JK</b>	 <b>STATE OF CONNECTICUT</b> <b>DEPARTMENT OF TRANSPORTATION</b>	SIGNATURE/ BLOCK:	PROJECT TITLE:  <b>BRIDGE REPLACEMENT BRIDGE NO. 04682 DUBLIN HILL ROAD OVER PONSET BROOK</b>	TOWN:  <b>HADDAM</b>	PROJECT NO. <b>060-161</b>
					CHECKED BY: <b>ADC</b>	DRAWING NO. <b>S-11</b>					
					SCALE AS NOTED	SHEET NO.					
REV.	DATE	REVISION DESCRIPTION	SHEET NO.	Plotted Date: 11/15/2017		Filename: ...\\SB-MSH-Br04682-060-161-S-11.dgn					



Hand-drawn plan view of a bridge deck. The diagram shows a rectangular layout with various dimensions and labels. At the top, a horizontal line is labeled "33.6' Field Measure". Above this line, there are two labels: "31'-0\" out BOX BEAMS" and "35'-0\" out BOX BEAMS". Below the top line, there are several vertical lines representing box beams. The spacing between these lines is labeled as "5'-3\"", "6'-3\"", "6'-3\"", "6'-3\"", "6'-3\"", "6'-3\"", "6'-3\"", "6'-3\"", "6'-3\"", "6'-3\"", and "1'-6\"". On the left side, there is a vertical line labeled "12x14 EC. 2 INSERTS FOR 12 FENCE POSTS TYP @ BOTH SIDES". Below this line, there is a label "6'-0\"". On the right side, there is a vertical line labeled "1'-6\"". In the center, there is a label "2'-11\" / 3'-6\"". At the bottom, there is a label "VOIDS TYPICAL ALL BOX BEAMS". On the left side, there is a label "DUBLIN RD. BRIDGE". On the right side, there is a label "C.N.B. SUGGEST". The diagram also shows various points labeled "B1B", "B1A", "B1C", "B2B", "B2A", "B2C", "A", and "B".

$$\begin{array}{r} 6.25 \\ 2 \\ \hline 25.00 \\ 5.25 \\ \hline 20.25 \\ 4.67 \\ \hline 34.92 \\ .08 \\ \hline 35.00 \end{array}$$

1"  $\phi$  BOLTS FOR  
RAILING POST  
BY C.W.B.

FENCE POST  
BY OTHERS

FILL SHEAR KEY WITH  
NON SHRINK GROUT AFTER  
TRANSVERSE TENSIONING  
BY C.W.B.

MEMBRANE WATERPROOFING  
BY OTHERS

1"  $\phi$  INSERTS  
CAST IN BEAMS

NOTCH

9:

SECTION B-B

C.M.B SUGGEST  
CHEEK WALLS  
ON EA SIDE OF  
BRIDGE  
CAN'T DO BECAUSE  
PIER IS NOT LONG  
ENOUGH

PLAN

82. TYPICAL EA END  
OF BOX BEAMS

5" X 1" X 2-1/4" NEOP. BRG. PAD ✓  
BY C.W.B.

SECTION C-C

DESIGN LOADS  
LOADS: H20-516-44  
WEARING SURFACE 25 P.S.F.  
RAILING 22 P.S.F.

APPROVED 12/30  
J.O. R.


BRIDGE ON DUBLIN ROAD OVER BIBLE ROCK BROOK  
HADDAM, CONN.

DATE	///
SCALE	

**70% DESIGN SUBMISSION**



**FOR REFERENCE ONLY**

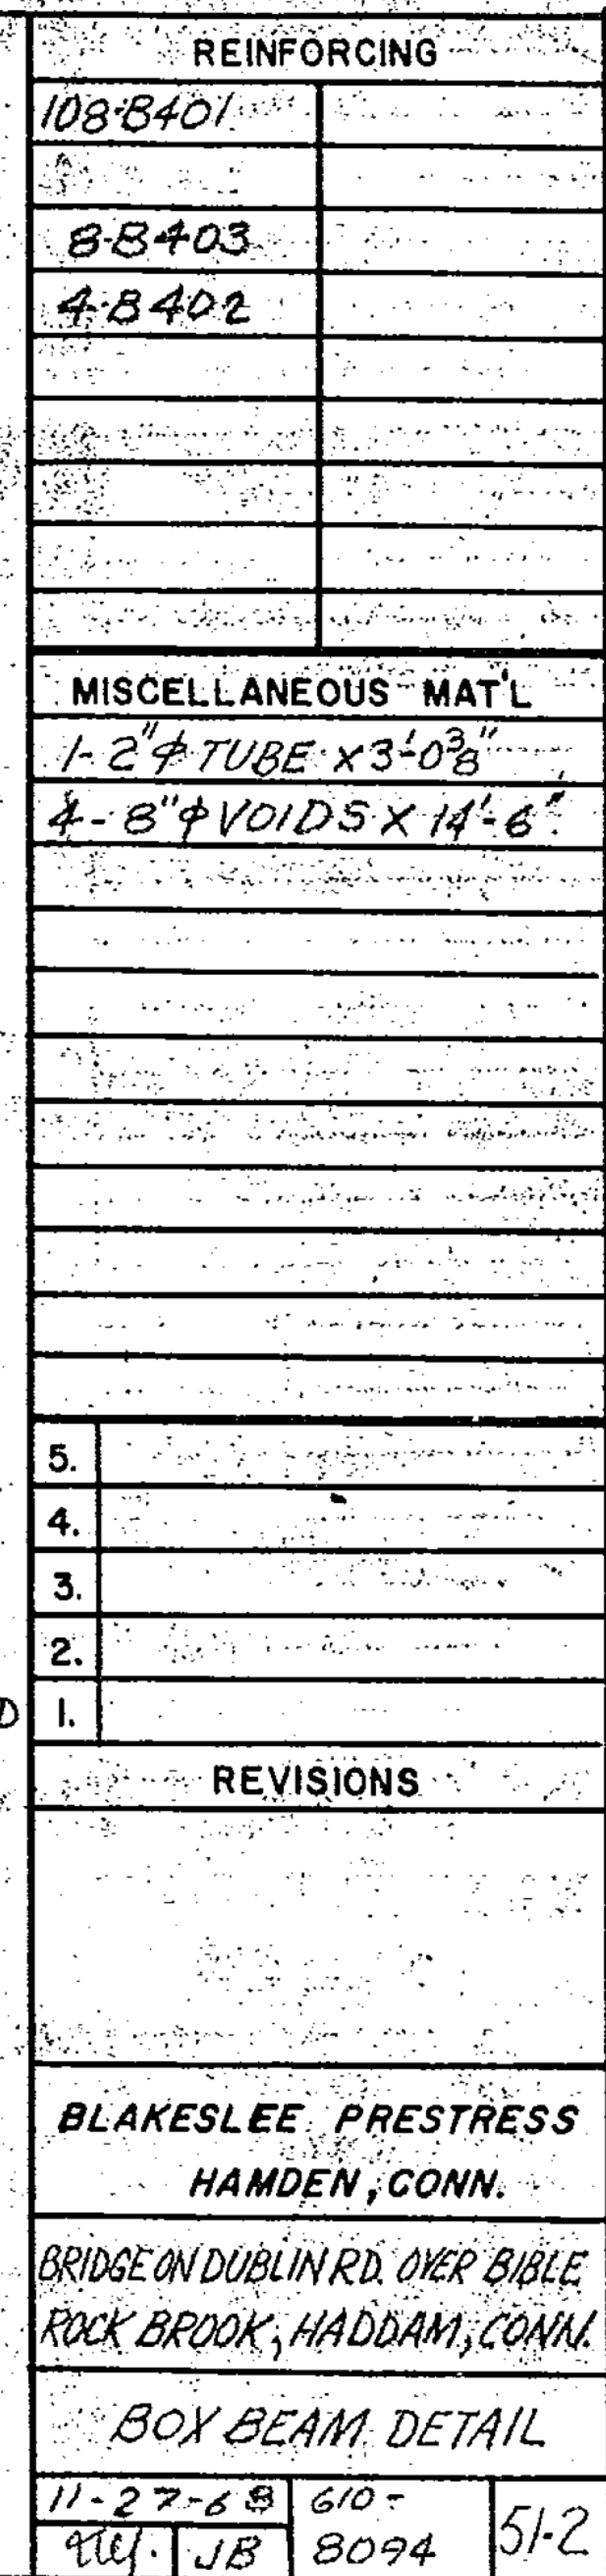[illegible]



CONC. HARD ROCK @ 155 P.S.F.  
 $f'_c = 5000$  @ 28 DAYS  
 $f_{ax} = 4000$  @ DESTRESS  
 AIR ENTRAINED 4% - 6%  
 WORK THIS SHI. WITH 51-200

## 70% DESIGN SUBMISSION

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														DRAWING TITLE: <b>EXISTING STRUCTURE DRAWING - 3</b>				DRAWING NO. <b>S-13</b>	
REV. DATE REVISION DESCRIPTION SHEET NO.				Plotted Date: 11/15/2017		Filename: ...\\SB-MSH-Br04682-060-161-S-13.dgn										SHEET NO.			








## 05 - TRAFFIC INDEX OF DRAWINGS

[illegible]


DESIGNED BY:  
A.DICESARE, ASSOCIATES, P.C.  
BRIDGEPORT, CT

## 70% DESIGN SUBMISSION

[illegible]

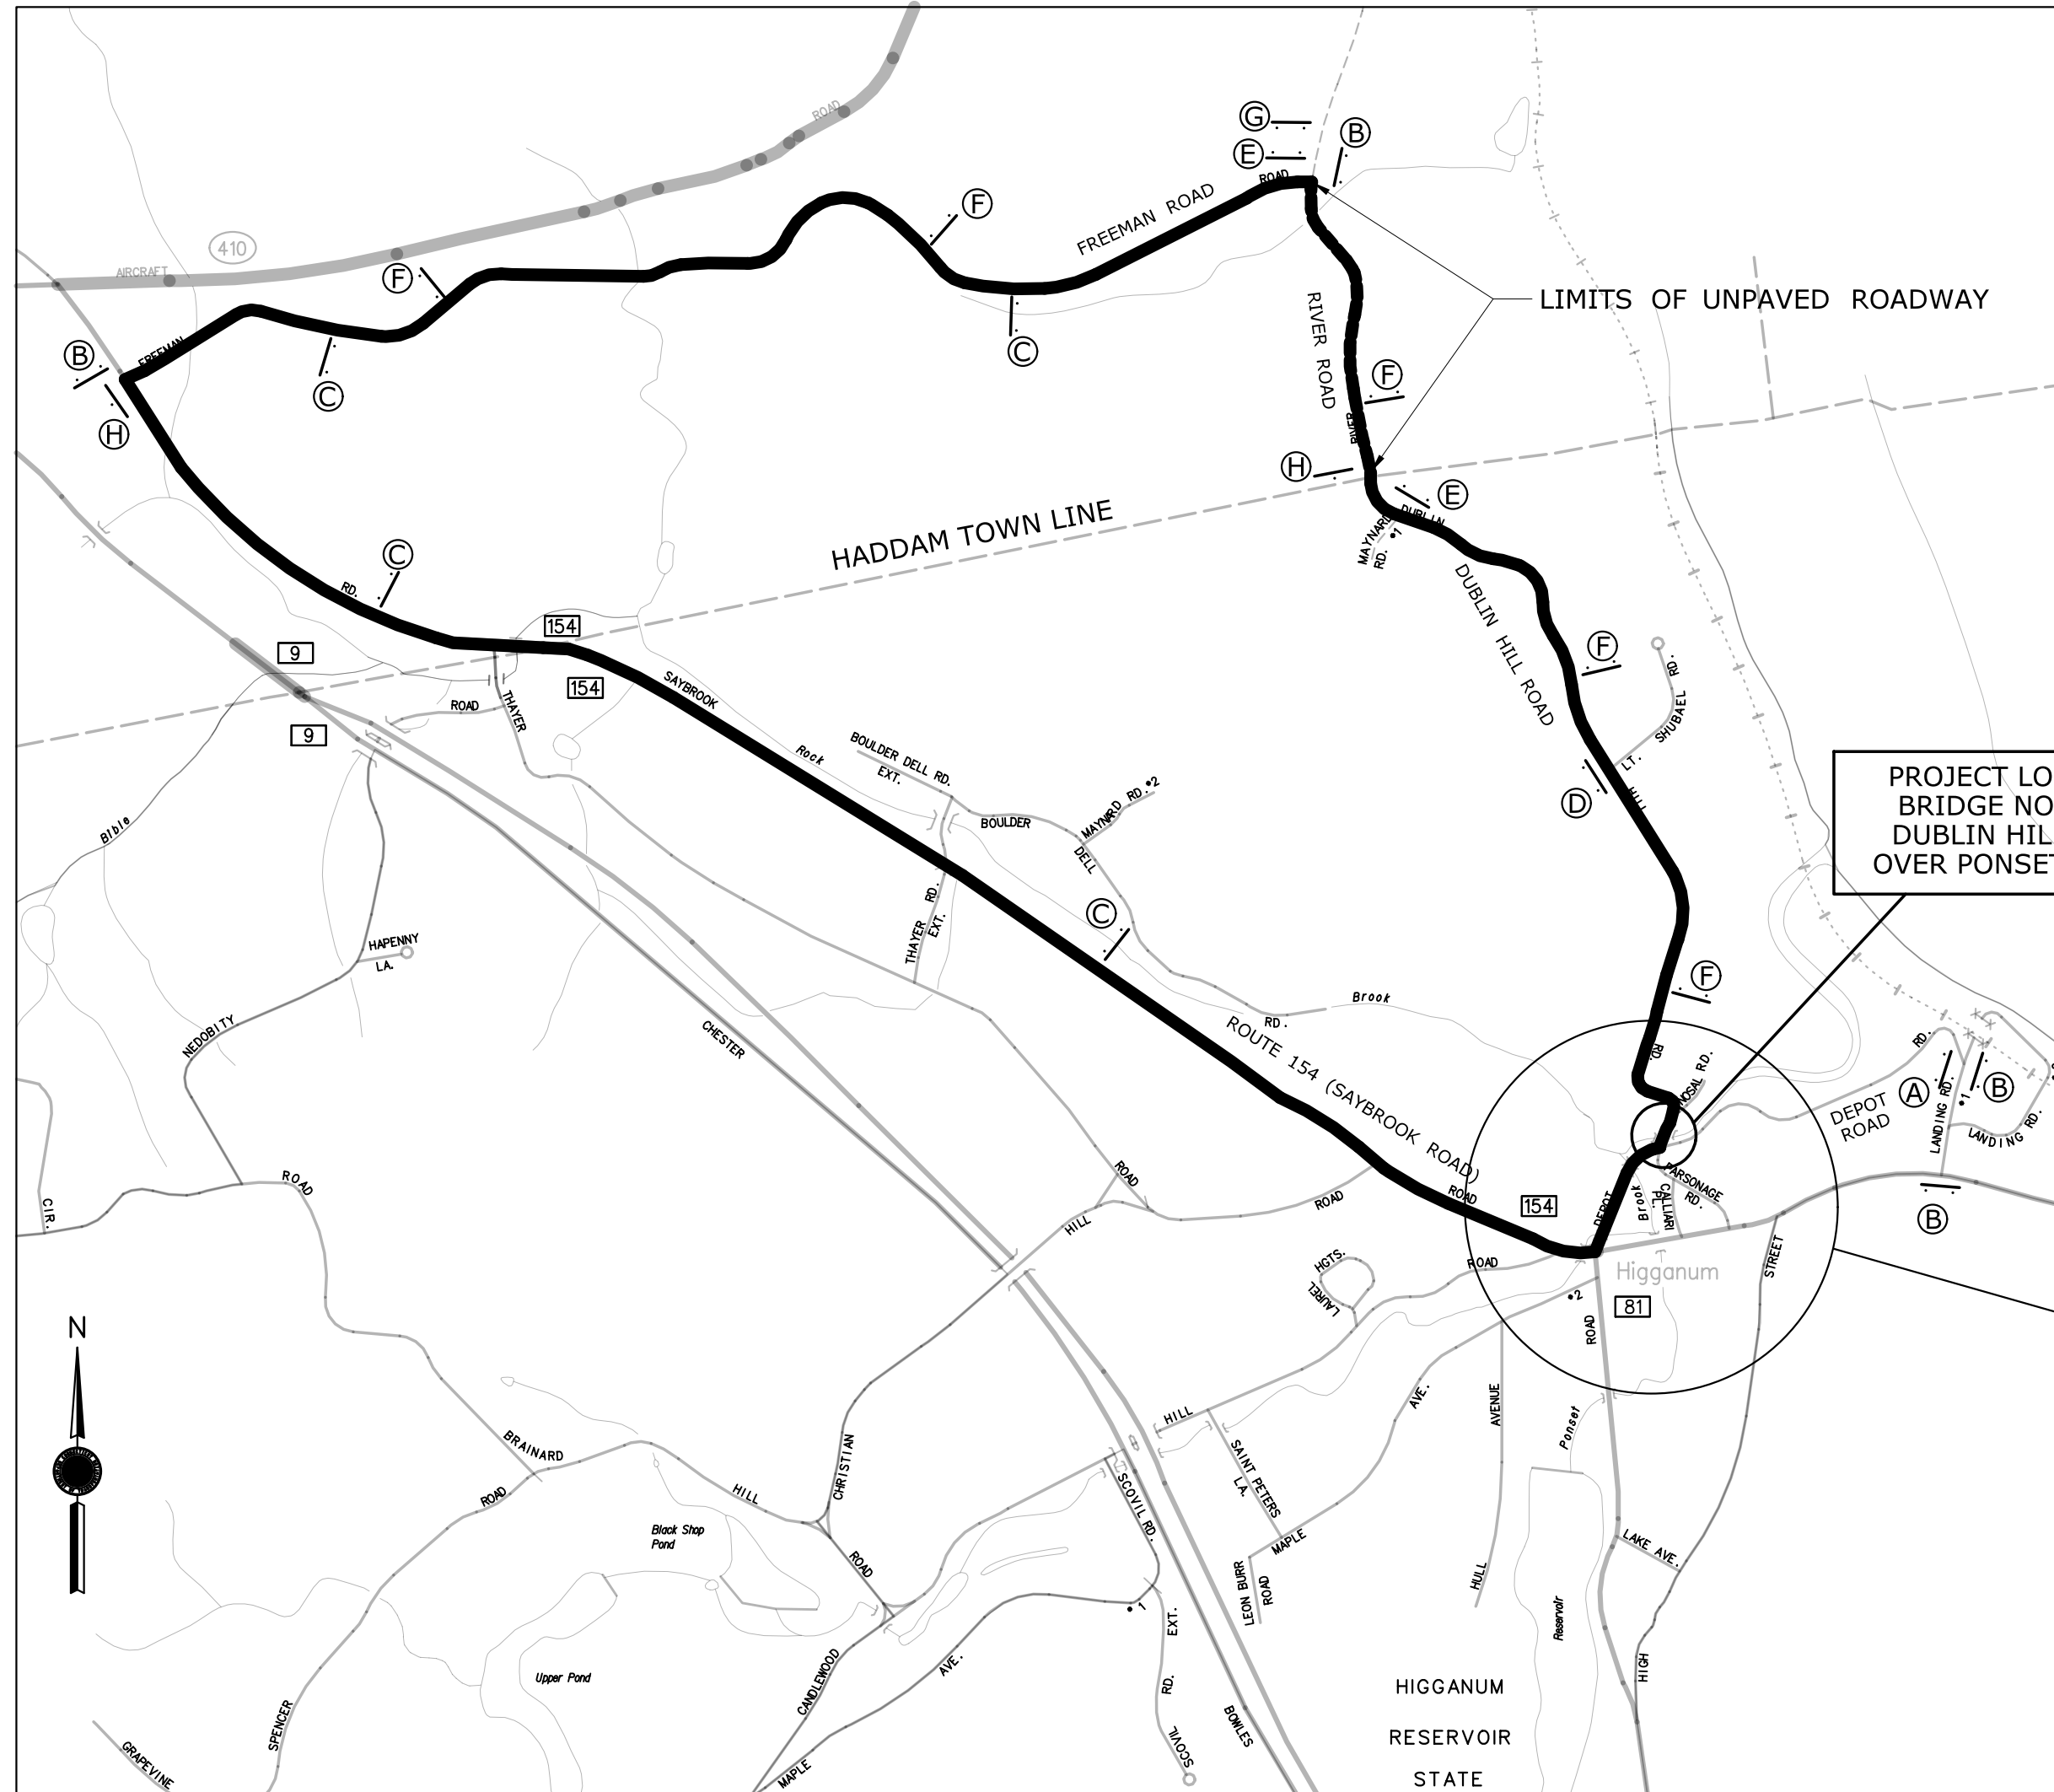

PROJECT LOCATION  
BRIDGE NO 04682  
DUBLIN HILL ROAD  
OVER PONSET BROOK

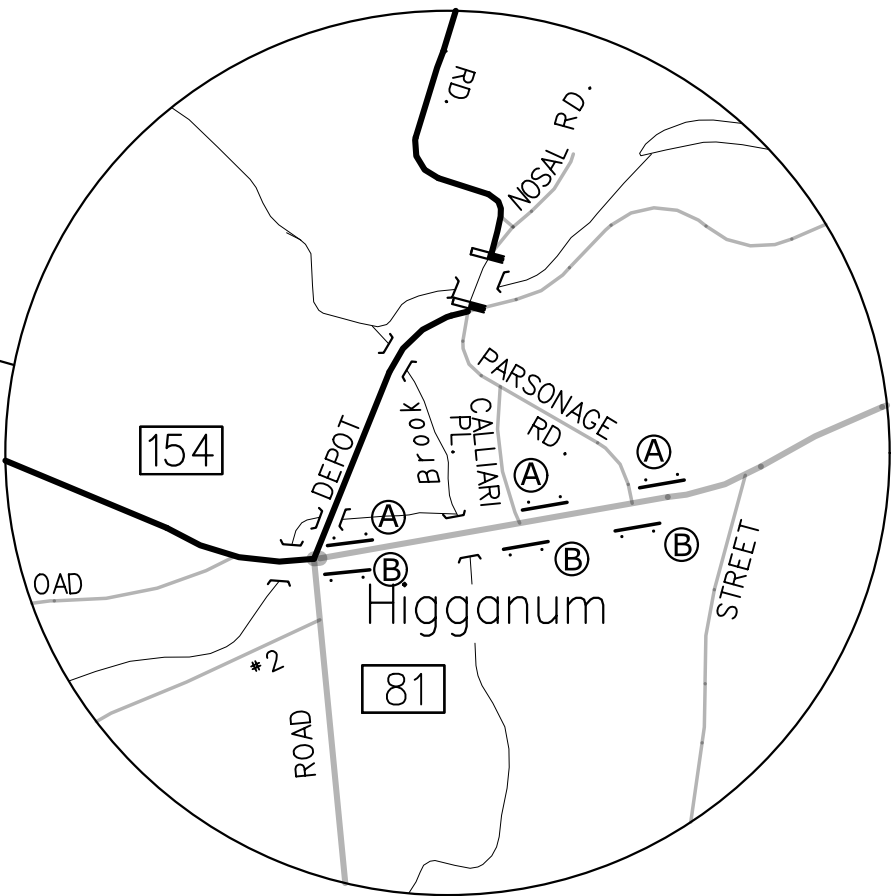

DETOUR LENGTH: 7.1 MILES

DETOUR PLAN  
N.T.S.

LEGEND:

- SINGLE POST SIGN
- DOUBLE POST SIGN
- TEMPORARY PRECAST CONCRETE BARRIER CURB

SIGN QUANTITIES AND DESCRIPTION


DOT SIGN CAT. No.	QTY.	SIGN DESCRIPTION
80-9081	2	ROAD CLOSED
80-9707	19	DETOUR
80-9913	11	ROAD SIGN (DUBLIN HILL RD)
80-9913	8	ROAD SIGN (SAYBROOK ROAD)
51-2631R	8	ARROW RIGHT
51-2625	9	ARROW UP
51-2630L	2	ARROW LEFT

DOT SIGN CAT. No.	QTY.	SIGN DESCRIPTION
80-9777	1	ROAD CLOSED LOCAL TRAFFIC ONLY
80-9702	1	DETOUR RIGHT
80-9708	2	END DETOUR

NOTES:

- THE DETOUR PLAN IS BEING PROVIDED AS MEANS TO ACCOMMODATE TRAFFIC DURING THE REPLACEMENT OF BRIDGE NO. 04682 OVER PONSET BROOK.
- AS REQUIRED BY THE PROJECT, THE CONTRACTOR SHALL ACTIVATE THIS DETOUR TO CLOSE OFF DUBLIN HILL ROAD. FOR CONVENIENCE OF THE PUBLIC, THE CONTRACTOR IS ADVISED TO MAINTAIN TRAFFIC ON DUBLIN HILL ROAD AS LONG AS POSSIBLE IN ACCORDANCE WITH THE SPECIAL PROVISION 1.08 "PROSECUTION AND PROGRESS" AND ITEM NO. 0971001A - "MAINTENANCE AND PROTECTION OF TRAFFIC". THE CONTRACTOR SHALL NOTIFY THE ENGINEER AT LEAST TWENTY ONE (21) DAYS IN ADVANCE PRIOR OF ACTIVATING THE DETOUR AND SHALL COORDINATE WITH OTHER PROJECTS IN THE AREA.
- THE CONTRACTOR SHALL MAINTAIN ACCESS TO ALL RESIDENTIAL, COMMERCIAL AND STATE PROPERTIES AT ALL TIMES.
- TWO WEEKS PRIOR TO INITIATING DETOUR, INSTALL SIGN NO. 80-9079 ON DUBLIN HILL ROAD IN BOTH DIRECTIONS IN VICINITY OF BRIDGE. THESE SIGNS SHALL BE REMOVED ONCE THE DETOUR IS IN EFFECT.
- CONTRACTOR IS TO NOTIFY TOWN OF HADDAM EMERGENCY SERVICES AT LEAST TWO WEEKS PRIOR TO INITIATING DETOUR.
- CONTRACTOR IS TO NOTIFY THE TOWN OF HADDAM THREE WEEKS PRIOR TO INITIATING DETOUR.
- THE CONTRACTOR SHALL INSTALL ALL DETOUR SIGNS SHOWN ON THIS PLAN PRIOR TO ACTIVATING THIS DETOUR AND SHALL COVER THE SIGNS WHENEVER THE DETOUR IS NOT IN USE. THE CONTRACTOR SHALL REMOVE ALL DETOUR SIGNS WHEN THE DETOUR IS NO LONGER NEEDED.
- THE LOCATIONS OF SIGNS AND TRAFFIC CONTROL DEVICES SHOWN ON PLANS ARE APPROXIMATE AND SHALL BE VERIFIED BY THE ENGINEER IN THE FIELD.
- EXISTING SIGNS ARE TO BE COVERED OR RELOCATED AS DIRECTED BY THE ENGINEER DURING CONSTRUCTION SO THAT THEY ARE IN APPROPRIATE LOCATIONS AND VISIBLE TO MOTORISTS. SOME SIGNS MAY HAVE TO BE TEMPORARILY RELOCATED WITHIN THE WORK AREA. THIS WORK SHALL BE PAID FOR UNDER THE ITEM NO. 0971001A "MAINTENANCE AND PROTECTION OF TRAFFIC."
- EXISTING SIGNS IN CONFLICT WITH TEMPORARY SIGNS SHALL BE COVERED, REMOVED OR REVISED.
- EXISTING CONFLICTING PAVEMENT MARKINGS SHALL BE REMOVED OR TEMPORARILY COVERED DURING THE DETOUR, INCLUDING THOSE PAVEMENT MARKINGS OUTSIDE THE TRAVELWAY.
- THE CONTRACTOR SHALL PROVIDE ANY ADDITIONAL STATIC SIGNS AT THE LOCATIONS SPECIFIED BY THE ENGINEER.
- BARRICADE WARNING LIGHTS HIGH INTENSITY SHALL BE MOUNTED ON ALL DIAMOND SHAPED POST-MOUNTED CONSTRUCTION SIGNS OR AS OTHERWISE NOTED.
- ALL DETOUR SIGNS SHALL BE PAID UNDER ITEM NO. 1220027, "CONSTRUCTION SIGNS"; RELOCATION OF TEMPORARY PRECAST CONCRETE BARRIER CURB (TPCBC) FOR DAILY ACCESS WILL BE INCLUDED IN THE GENERAL COST OF CONSTRUCTION AND WILL NOT BE PAID SEPARATELY.
- ALL CONSTRUCTION SIGNS TO BE INSTALLED ON BREAKAWAY POSTS PER TRAFFIC STANDARD SHEETS.
- TYPE DE-7 AND DE-7A DELINEATORS SHALL BE INSTALLED ON TPCBC AS SPECIFIED ON THE STANDARD SHEET "DELINEATION, DELINEATOR, AND OBJECT MARKER DETAILS".
- ALL WORK SHALL BE PERFORMED IN ACCORDANCE WITH THE SPECIAL PROVISIONS FOR SECTION 1.08 PROSECUTION AND PROGRESS AND ITEM NO. 0971001A "MAINTENANCE AND PROTECTION OF TRAFFIC".
- ANY EXISTING SIGNING DAMAGED BY THE CONTRACTOR SHALL BE REPLACED AT NO COST TO THE STATE.
- EXISTING OR TEMPORARY ILLUMINATION SHALL REMAIN OPERATIONAL AT ALL TIMES.
- UPON COMPLETION OF WORK ALL EXISTING SIGNS AND PAVEMENT MARKINGS SHALL BE RE-ESTABLISHED AS ORDERED BY THE ENGINEER.

70% DESIGN SUBMISSION

				DESIGNER/DRAFTER: <b>AG</b>	 <b>STATE OF CONNECTICUT</b> <b>DEPARTMENT OF TRANSPORTATION</b>	SIGNATURE/ BLOCK:	PROJECT TITLE:  <b>BRIDGE REPLACEMENT BRIDGE NO. 04682 DUBLIN HILL ROAD OVER PONSET BROOK</b>	CITY:  <b>HADDAM</b>	PROJECT NO. <b>060-161</b>
				CHECKED BY: <b>ADC</b>					DRAWING NO. <b>TR-02</b>
				SCALE AS NOTED					SHEET NO.
REV.	DATE	REVISION DESCRIPTION	SHEET NO.	Plotted Date: 11/15/2017	Filename: ...\\TR_MSH_Br04682_060_161_TR-02.dgn				

THE INFORMATION, INCLUDING ESTIMATED QUANTITIES OF WORK, SHOWN ON THESE SHEETS IS BASED ON LIMITED INVESTIGATIONS AND IS IN NO WAY WARRANTED TO INDICATE THE CONDITIONS OF ACTUAL QUANTITIES OF WORK WHICH WILL BE REQUIRED.

DRAWING NO. <b>TR-02</b>	PROJECT NO. <b>060-161</b>
SHEET NO.	









